

VETERANS SUPPORTIVE HOUSING

MARINA, CA 93933

PROJECT TEAM

CO-DEVELOPER
 ECUMENICAL ASSOCIATION FOR HOUSING
 2169 E. Francisco Blvd., Suite B
 San Rafael, CA 94901
 Phone: 415-295-8886
 CONTACT: ETHAN DANIELS
 ethan.daniels@EAHousing.org

ARCHITECT
 HKIT ARCHITECTS
 538 Ninth Street, Suite 240 Oakland CA 94607
 Phone: 510 625-9800 Fax: 510 625 9801
 CONTACT: RICH CALDWELL
 rcaldwell@hkit.com

CO-DEVELOPER
 VETERANS TRANSITION CENTER
 OF MONTEREY COUNTY
 220 Twelfth St, Marina CA 93933
 Phone: 831 883-8387
 CONTACT: WILLIAM TERRY BARE
 wbare@vtcmonterey.org

LANDSCAPE ARCHITECT
 VAN DORN ABED LANDSCAPE ARCHITECTS INC.
 81 14th Street San Francisco, CA 94103
 Phone: 415 864-1921 Fax: 415 864-4796
 CONTACT: SHARI VAN DORN
 shari@valainc.com

CIVIL ENGINEER
 WHITSON ENGINEERS
 9699 Blue Larkspur Lane, Suite 105
 Monterey, CA 93940
 Phone: 831 649-5225
 CONTACT: RICHARD WEBER
 rweber@whitsonengineers.com

PROJECT DATA

PROJECT INFORMATION		REFERENCE
ZONE	PROJECT SITE ADJACENT ZONES	R-4 SOUTHWEST: OPEN SPACE ACROSS HAYES CIRC: R-4 TO NORTHWEST: R-1 "CYPRESS KNOLLS"
USES	GENERAL PLAN AREA PERMITTED CONDITIONAL USE PERMIT 2013 CBC OCCUPANCY	17.20.030 17.20.030
SITE AREA	SQUARE FEET ACRES	104,365 S.F. 2.40 ACRES
DENSITY	UNITS / ACRE MINIMUM DENSITY MAX ALLOWABLE (NO BONUS) PROPOSED UNITS / ACRE	15 UN/ACRE 35 UN/ACRE 30 UN/ACRE
F.A.R.	PROPOSED FAR (CONDITIONED ONLY)	0.52
HEIGHT	CONSTRUCTION MAX. ALLOWABLE HEIGHT PROPOSED HEIGHT EXCEPTIONS	TYPE VA (ONE-HOUR WOOD FRAMED) 42' 42' MAX MECH EQUIP, ARCH FEATURES
LOT COVERAGE	LOT COVERAGE ALLOWABLE LOT COVERAGE PROPOSED - AREA LOT COVERAGE PROPOSED - PERCENTAGE	60% 19,485 19%
YARDS AND COURTS	FRONT - HAYES CIRCLE SIDE ADJACENT R-4 SIDE ADJACENT R-1 REAR YARDS	12' 5' 17' 10'
OPEN SPACE (S.F.)	REQUIREMENTS: MAX SLOPE MIN. DIMENSION INDOOR SPACE COUNTED TOWARDS TOTAL REQUIRED > PER STUDIO APT: 300 SF PER UNIT > PER 2BR AT 400 S.F. PER UNIT TOTAL REQUIRED AREA REQUIRED PRIVATE OPEN SPACE PER UNIT: >80 S.F. PATIOS AT GROUND LEVEL >40 S.F. BALCONS AT UPPER LEVEL TOTAL REQUIRED PRIVATE OPEN SPACE PROVIDED - COMMON OUTDOOR COMMON OPEN SPACE INDOOR COMMON OPEN SPACE (300 S.F. MIN) TOTAL COMMON PROVIDED PROVIDED - PRIVATE TYPICAL PATIO AT GROUND FLOOR LEVEL TYPICAL BALCONY AT UPPER FLOOR LEVEL TOTAL PRIVATE OPEN SPACE PROVIDED GRAND TOTAL OPEN SPACE	10% 6' ROOMS 300 S.F. OR MORE 19,200 S.F. 2,800 S.F. 22,000 S.F. 1,840 S.F. 1,960 S.F. 3,800 S.F. 26,352 S.F. 1,770 S.F. 28,122 S.F. 1,955 S.F. 2,058 S.F. 4,013 S.F. 32,135 S.F.
UNITS	STUDIO-BEDROOM TWO-BEDROOM TOTAL	64 7 71
BUILDING AREA (S.F.) - GROSS AREAS	FLOOR 1 CONDITIONED UNCONDITIONED (COVERED WALKWAY) FLOOR 2 CONDITIONED UNCONDITIONED (COVERED WALKWAY) FLOOR 3 CONDITIONED UNCONDITIONED (COVERED WALKWAY) TOTAL CONDITIONED AREA TOTAL UNCONDITIONED AREA TOTAL OVERALL AREA	19,339 S.F. 146 S.F. 18,387 S.F. 374 S.F. 16,754 S.F. 374 S.F. 54,460 894 S.F. 55,374 S.F.
PARKING	RESIDENTIAL PER CA A.B. 744 * * 3 STALLS / BEDROOM (INCLUSIVE H.C. AND VISITOR PKG) STUDIO: .3 PER UNIT (1:1 COVERED) TWO BR: .6 PER UNIT (1:1 COVERED) TOTAL REQUIRED PARKING PROVIDED ON-SITE MIN. STALL DIMENSIONS AISLE BICYCLES SHORT TERM PROVIDED LONG TERM PROVIDED	WHEN MAX. AFFORDABLE + SPECIAL NEEDS + 1/2 MILE TO TRANSIT 20.0 STALLS 5.0 STALLS 25 STALLS 60 STALLS 9'x19' 25' 8 BIKES 18 BIKES



VIEW FACING NORTHWEST ALONG MILLER


APPLICABLE CODES

UFAS: ACCESSIBLE UNITS
 FAIR HOUSING GUIDELINES: COMMON AREAS AND VISITABLE/ADAPTABLE UNITS
 2013 CBC, INCLUDING CHAPTER 11B FOR COMMON AREAS AND ACCESSIBLE UNITS
 2013 CBC CHAPTER 11A FOR ADAPTABLE UNITS
 2013 CA PLUMBING, ELECTRICAL, FIRE CODES
 2013 CA ENERGY CODE
 2013 GREEN BUILDING STANDARDS - RESIDENTIAL MANDATORY MEASURES
 2010 ADA: TITLE III PUBLIC AREAS AND ACCESSIBLE UNITS

SHEET INDEX

#	TITLE
GENERAL	
G0.0	PROJECT INFORMATION
CIVIL	
C0.1	PRELIMINARY CIVIL TITLE SHEET
C1.0	TOPOGRAPHIC SURVEY
C1.1	PRELIMINARY CIVIL SITE PLAN
LANDSCAPE	
L1.1	PRELIMINARY LANDSCAPE PLAN
L2.1	PRELIMINARY PLANT PALETTE
L3.1	IRRIGATION EQUIPMENT LIST AND DETAILS
L3.2	IRRIGATION DETAILS
L3.3	IRRIGATION DETAILS
L4.1	TREE PRESERVATION AND REMOVAL PLAN
ARCHITECTURAL	
A0.1	CONCEPTUAL RENDERINGS
A0.2	CONCEPTUAL RENDERINGS
A1.1	SITE PLAN
A2.1	FLOOR 1 PLAN
A2.2	FLOOR 2 PLAN
A2.3	FLOOR 3 PLAN
A2.4	ROOF PLAN
A3.0	EXTERIOR ELEVATIONS
A3.1	EXTERIOR ELEVATIONS

VICINITY MAP

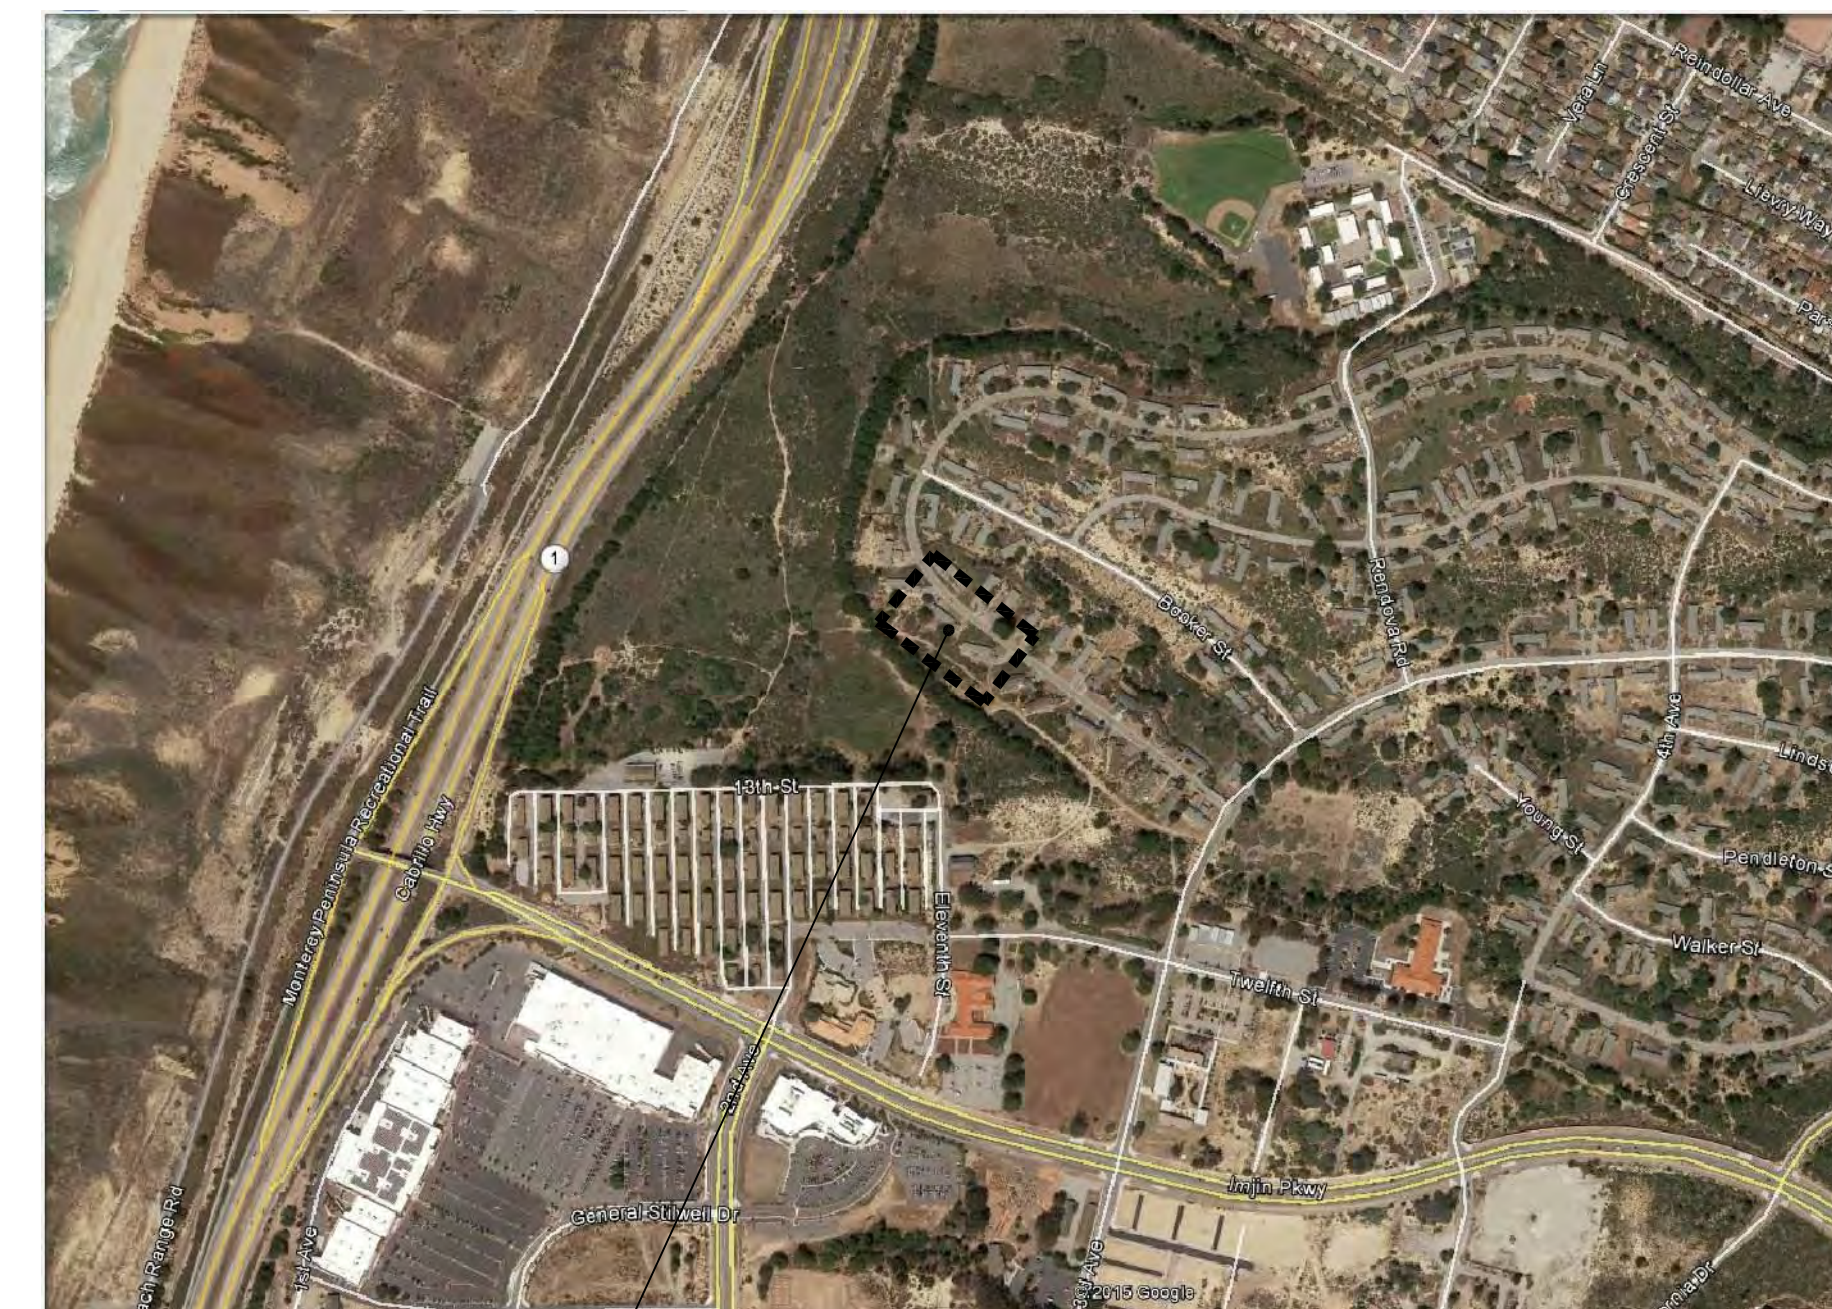

SITE

VETERANS SUPPORTIVE HOUSING V.T.C / E.A.H

MARINA, CALIFORNIA

JOB NO. 30043
 DRAWN .
 CHECKED .
 JOB CAPTAIN PM
 DATE 12/21/2015
 DESIGN REVIEW APPLICATION
 2/11/2016
 DESIGN REVIEW RESUBMITTAL

DRAWING TITLE
PROJECT INFORMATION

SCALE AS NOTED

GO.0
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GENERAL NOTES

- 1. CONSTRUCTION CONTRACTOR AGREES THAT, IN ACCORDANCE WITH GENERALLY ACCEPTED CONSTRUCTION PRACTICES, CONSTRUCTION CONTRACTOR WILL BE REQUIRED TO ASSUME SOLE AND COMPLETE RESPONSIBILITY FOR JOB CONDITIONS DURING THE COURSE OF CONSTRUCTION OF THE PROJECT...


GRADING NOTES

- 1. SITE GRADING SHALL BE DONE IN CONFORMANCE WITH THE PROJECT GEOTECHNICAL REPORT ENTITLED: GEOTECHNICAL INVESTIGATION:xxx MARINA, CALIFORNIA BY MOORE TWNING ASSOCIATES, INC, xxx, 2016

LEGEND

Legend table listing symbols for property boundary, existing/finished/proposed grades, storm/sanitary sewer lines, water lines, fire service lines, and various manholes/easements.

VICINITY MAP

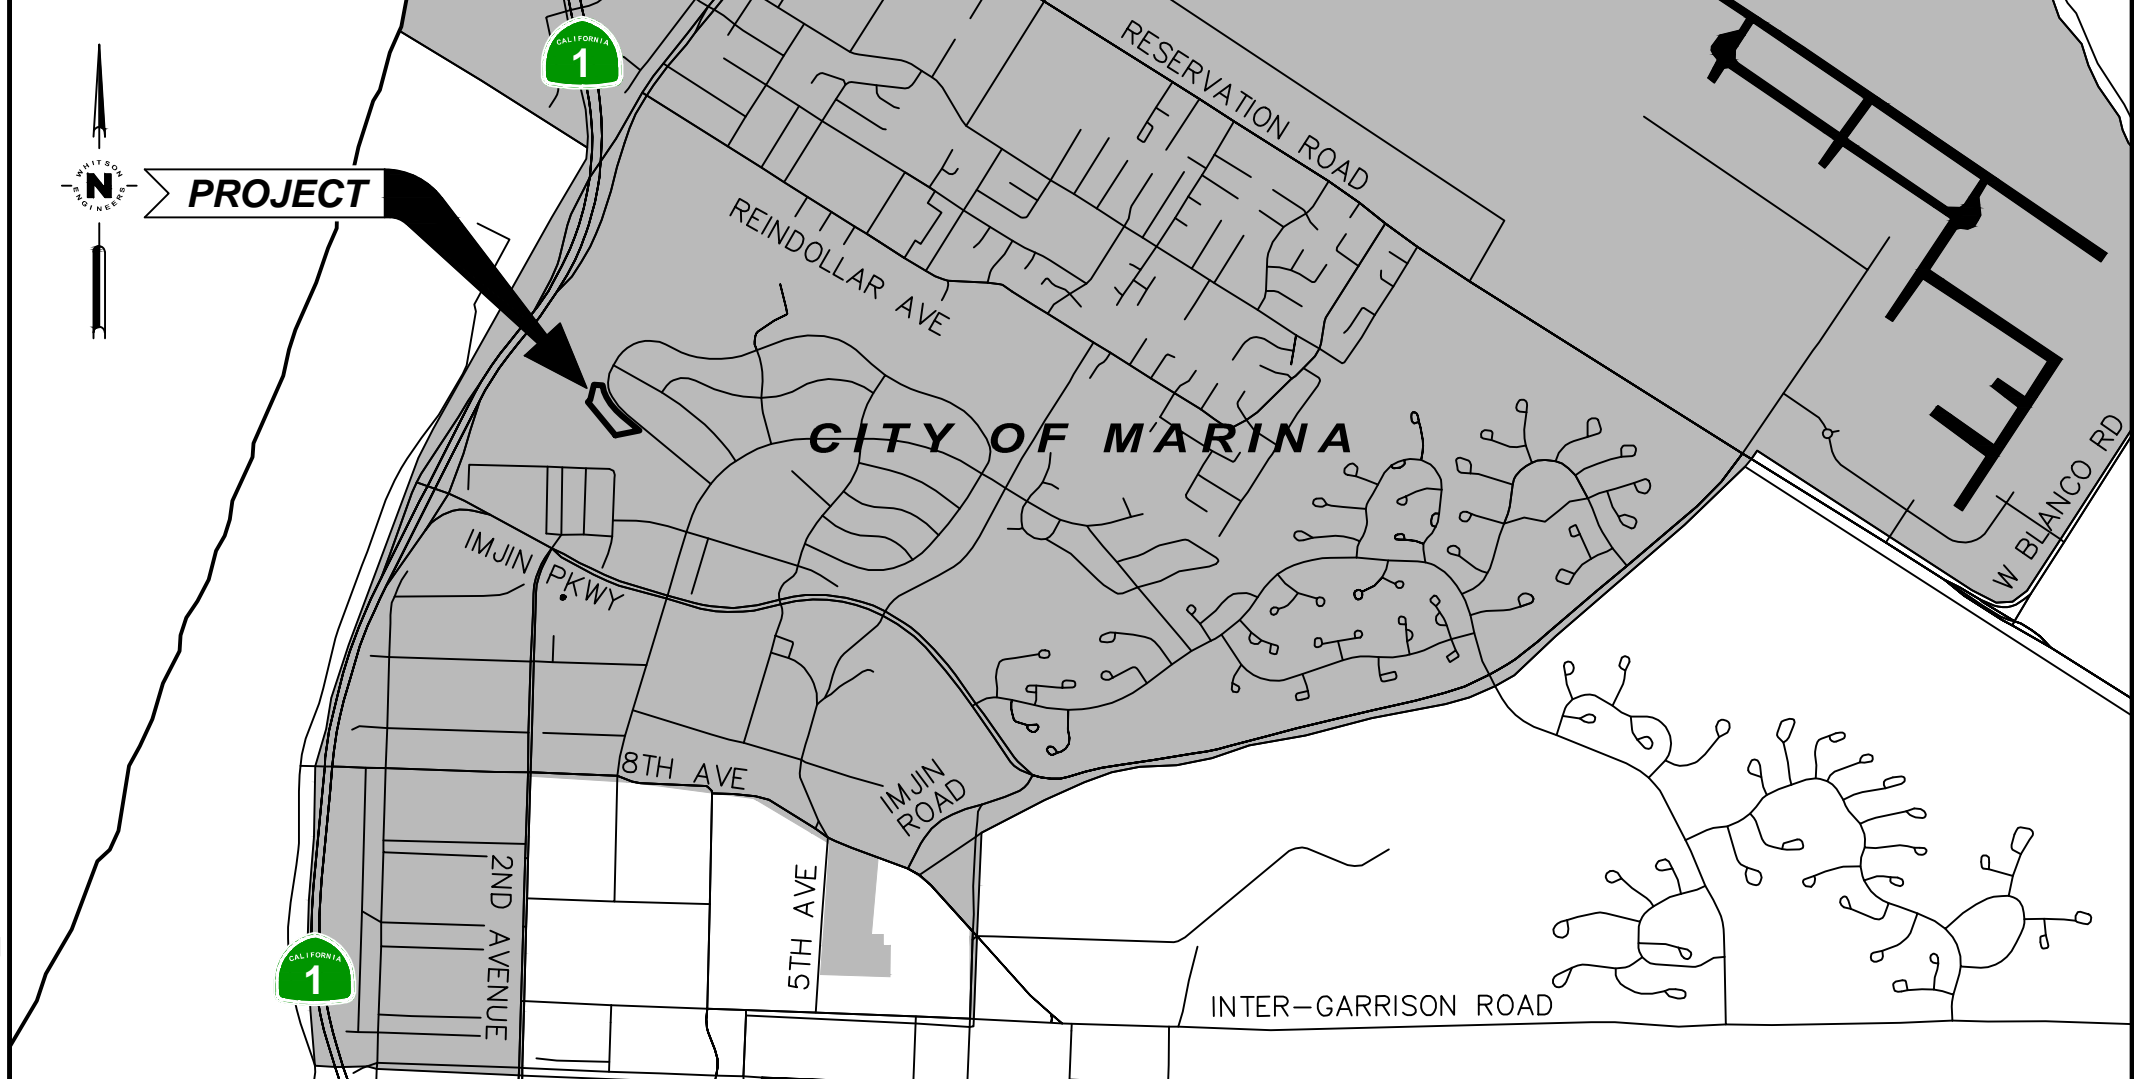

CIVIL SHEET INDEX

Table listing sheet numbers and titles: C0.1 PRELIMINARY CIVIL TITLE SHEET, C1.0 TOPOGRAPHIC SURVEY, C1.1 PRELIMINARY CIVIL SITE PLAN.

PROJECT TEAM / DIRECTORY

Project team directory listing roles and contact information for Developer, Architect, Civil Engineer/Surveyor, Landscape Architect, Geotechnical Engineer, and Grading Contractor.

EARTHWORK SUMMARY table with columns for Description, Cut (CY), and Fill (CY). Total cut is 3,750 CY and total fill is 2,900 CY.

BENCHMARK LOCAL BENCHMARK: MAG NAIL SET AT THE LOCATION SHOWN ON SHEET C1.0. ELEVATION: 76.18' (ASSUMED DATUM)



MARINA COAST WATER DISTRICT logo and contact information: 11 RESERVATION ROAD, MARINA, CA 93933, (831) 384-6131.

Approval section with fields for 'Reviewed by', 'Date', 'APPROVED BY CITY OF MARINA FIRE CHIEF', and 'APPROVED' by Nourdin Khayata, Acting City Engineer.

THE GEOTECHNICAL ASPECTS OF THE IMPROVEMENT PLANS HAVE BEEN REVIEWED FOR SUBSTANTIAL CONFORMANCE WITH THE INTENT OF THE RECOMMENDATIONS CONTAINED IN THE GEOTECHNICAL INVESTIGATION BY GEOCON.

HKIT ARCHITECTS logo and address: 538 NINTH STREET SUITE 240 • OAKLAND, CA 94607



WHITSON ENGINEERS logo and address: 9699 Blue Larkspur Lane • Suite 105 • Monterey, CA 93940

VETERANS SUPPORTIVE HOUSING

MARINA, CALIFORNIA JOB NO. 30043 | WE: 3394.01 DRAWN RFW CHECKED RFW JOB CAPTAIN DATE 2/10/2016 DESIGN REVIEW APPLICATION

DRAWING TITLE PRELIMINARY CIVIL TITLE SHEET

SCALE AS NOTED

C0.1



VETERANS SUPPORTIVE HOUSING

MARINA, CALIFORNIA
 JOB NO. 30043 | WE: 3394.01
 DRAWN RPW
 CHECKED RPW
 JOB CAPTAIN FM
 DATE 12/21/2015
 DESIGN REVIEW APPLICATION

DRAWING TITLE
TOPGRAPHIC SURVEY

SCALE AS NOTED

C1.0
 0 1 2 INCHES 3



- NOTES:**
- THIS MAP REPRESENTS A TOPOGRAPHIC SURVEY PERFORMED BY WHITSON ENGINEERS ON 11/12/15 & 11/13/15.
 - THIS MAP PORTRAYS THE SITE AT THE TIME OF THE SURVEY AND DOES NOT SHOW SOILS OR GEOLOGY INFORMATION, UNDERGROUND CONDITIONS, EASEMENTS, ZONING OR REGULATORY INFORMATION OR ANY OTHER ITEMS NOT SPECIFICALLY REQUESTED BY THE CLIENT.
 - BOUNDARY LOCATIONS SHOWN HEREON WERE DETERMINED WITH THE BENEFIT OF A FIELD SURVEY SUPPLEMENTED BY RECORD DATA. ALL BOUNDARY SHOWN IS FROM RECORD DATA. THIS TOPOGRAPHY DOES NOT CONSTITUTE A BOUNDARY SURVEY. THERE MAY BE EASEMENTS OR OTHER RIGHTS, RECORDED OR UNRECORDED, AFFECTING THE SUBJECT PROPERTY WHICH ARE NOT SHOWN HEREON.
 - DISTANCES AND DIMENSIONS SHOWN ARE EXPRESSED IN FEET AND DECIMALS THEREOF, UNLESS OTHERWISE NOTED.
 - TEMPORARY BENCHMARK TAKEN AS MAG NAIL SET AT THE LOCATION SHOWN ON THIS PLAN. ELEVATION: 76.18' (ASSUMED DATUM)
 - UNDERGROUND UTILITIES, IF SHOWN, ARE BASED ON FIELD LOCATION OF VISIBLE SURFACE FEATURES IN CONJUNCTION WITH SCHEMATICS OF UNDERGROUND UTILITIES PROVIDED BY THE UTILITY OWNER. EXACT LOCATIONS AND DEPTHS SHOULD BE CONFIRMED PRIOR TO CONSTRUCTION.
 - DIAMETERS OF TREES ARE SHOWN IN INCHES. TREES SMALLER THAN 6" WERE NOT NECESSARILY LOCATED AS PART OF THIS SURVEY.


OH	OVERHEAD UTILITY LINE(S)
-G-	GAS LINE
⊙ GV	GAS VALVE
-S-	SANITARY SEWER LINE (GRAVITY)
⊙ SSCO	CLEANOUT
⊙ WV	WATER VALVE
FH	FIRE HYDRANT

ABBREVIATIONS

AC	ASPHALT CONCRETE
CONC	CONCRETE
CLF	CHAINLINK FENCE
ELEC	ELECTRIC
LDG	LANDING
P.T.	PROPANE TANK

LEGEND

100	GROUND CONTOUR
---	SUBJECT PROPERTY LINE
---	ADJACENT PROPERTY LINE
---	CENTER LINE
⊕ TBM	TEMPORARY BENCHMARK
△ 100	CONTROL POINT
⊙	FOUND IRON PIPE, TAGGED AS NOTED
+	SPOT GRADE
○	12" OAK
⌒	STUMP OR SNAG (DEAD)
⌒	TREE DRIP LINE
X	FENCE

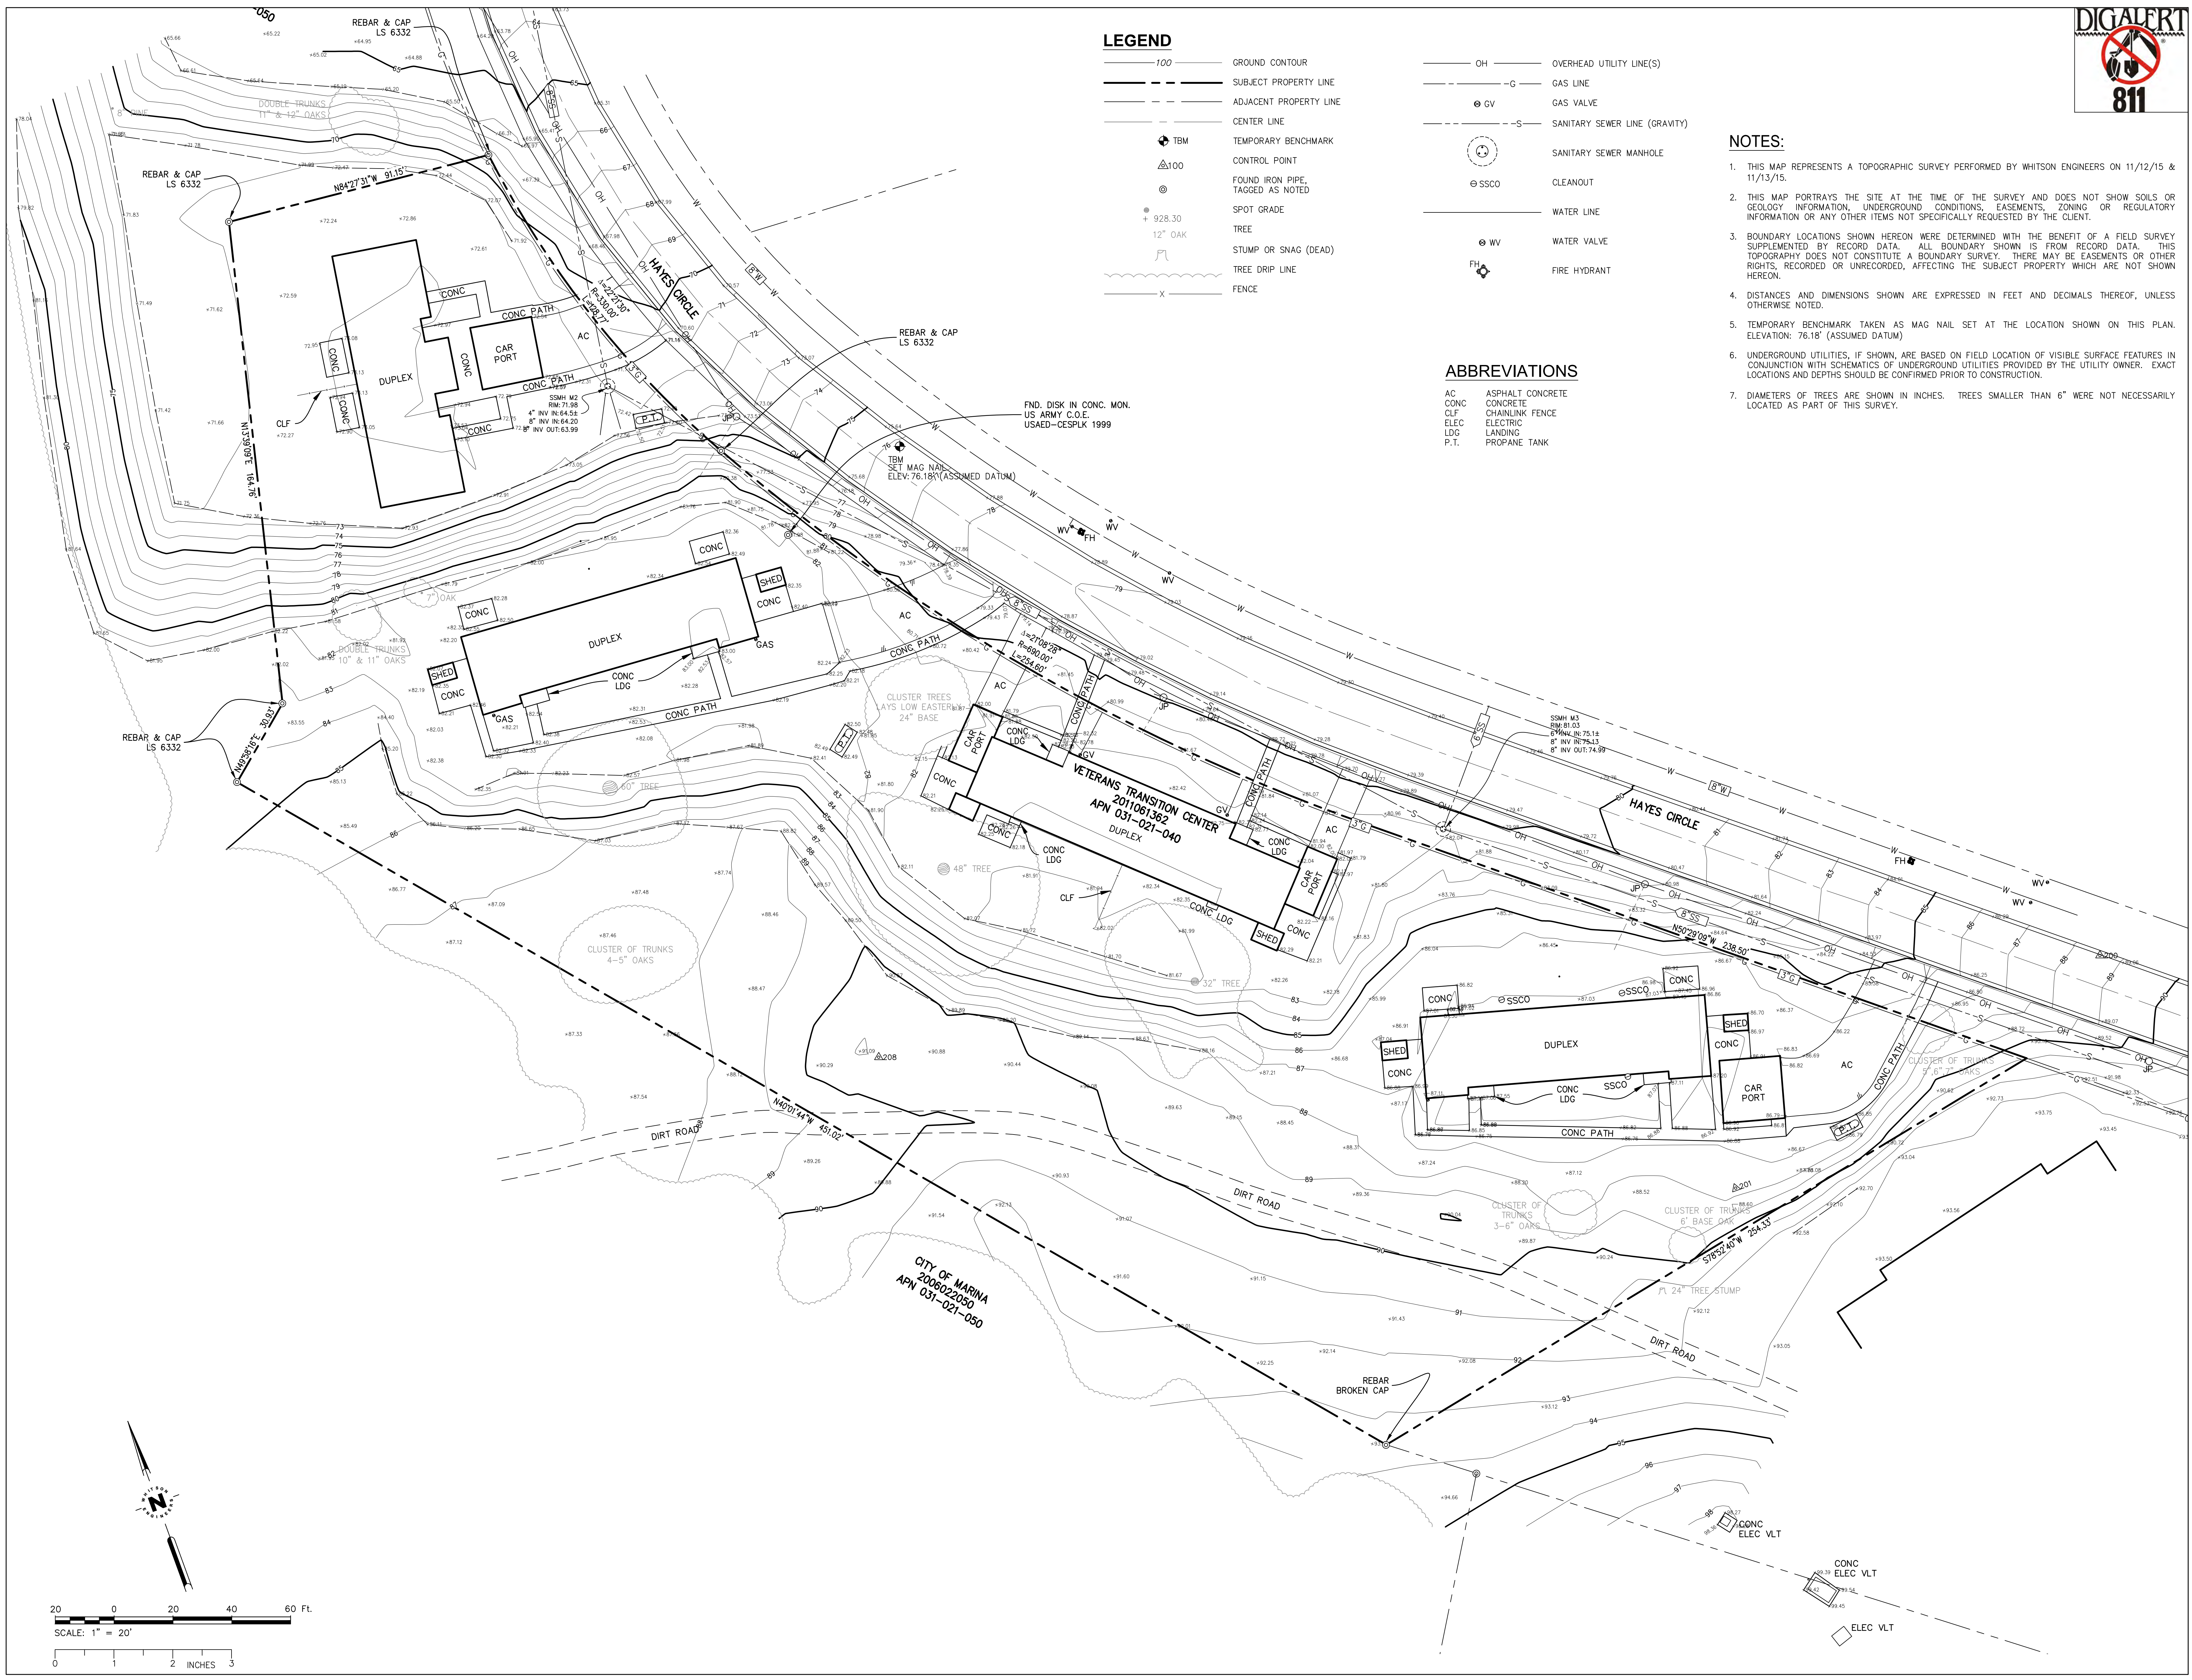

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WE WHITSON ENGINEERS
 9699 Blue Lakespur Lane • Suite 105 • Monterey, CA 93940
 831 649-5225 • Fax 831 373-5065
 CIVIL ENGINEERING • LAND SURVEYING • PROJECT MANAGEMENT

VETERANS SUPPORTIVE HOUSING

MARINA, CALIFORNIA

JOB NO. 30043 | WE: 3394.01
 DRAWN RPW
 CHECKED RPW
 JOB CAPTAIN
 DATE 2/10/2016
 DESIGN REVIEW APPLICATION

DRAWING TITLE
PRELIMINARY CIVIL SITE PLAN

SCALE AS NOTED


C1.1
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KEYNOTES

- 1 CONSTRUCT NEW DRIVEWAY APRON
- 2 ACCESSIBLE PARKING WITH DETECTABLE WARNING SURFACE
- 3 WATER MAIN POINT OF CONNECTION
- 4 WATER METER AND BACKFLOW DEVICES; TYP.
- 5 FIRE DEPARTMENT CONNECTION, PIV AND BACKFLOW DEVICE
- 6 DEMOLISH EX. DRIVEWAY APRON AND REPLACE WITH CONC. SIDEWALK
- 7 CONSTRUCT SANITARY SEWER MANHOLE AND PIPE PER MCWD STANDARDS
- 8 FIRE HYDRANT
- 9 DEMOLISH EX. SANITARY SEWER MANHOLE AND SEWER MAIN
- 10 PROTECT EXISTING TREE
- 11 CONSTRUCT RETAINING WALL
- 12 MOUNTABLE CURB AND FIRE DEPARTMENT TURNOUT
- 13 PAINT CURB RED "NO PARKING"



LAST SAVED: THURSDAY, MAY 21, 2015 12:31:49 PM BENCHLIST DWG FILE: E:\PROJECTS\DRAWINGS\TEMPLATES\SHEETS\LANDPROT.DWG XREF: JALLES 0 WHER END_LIST

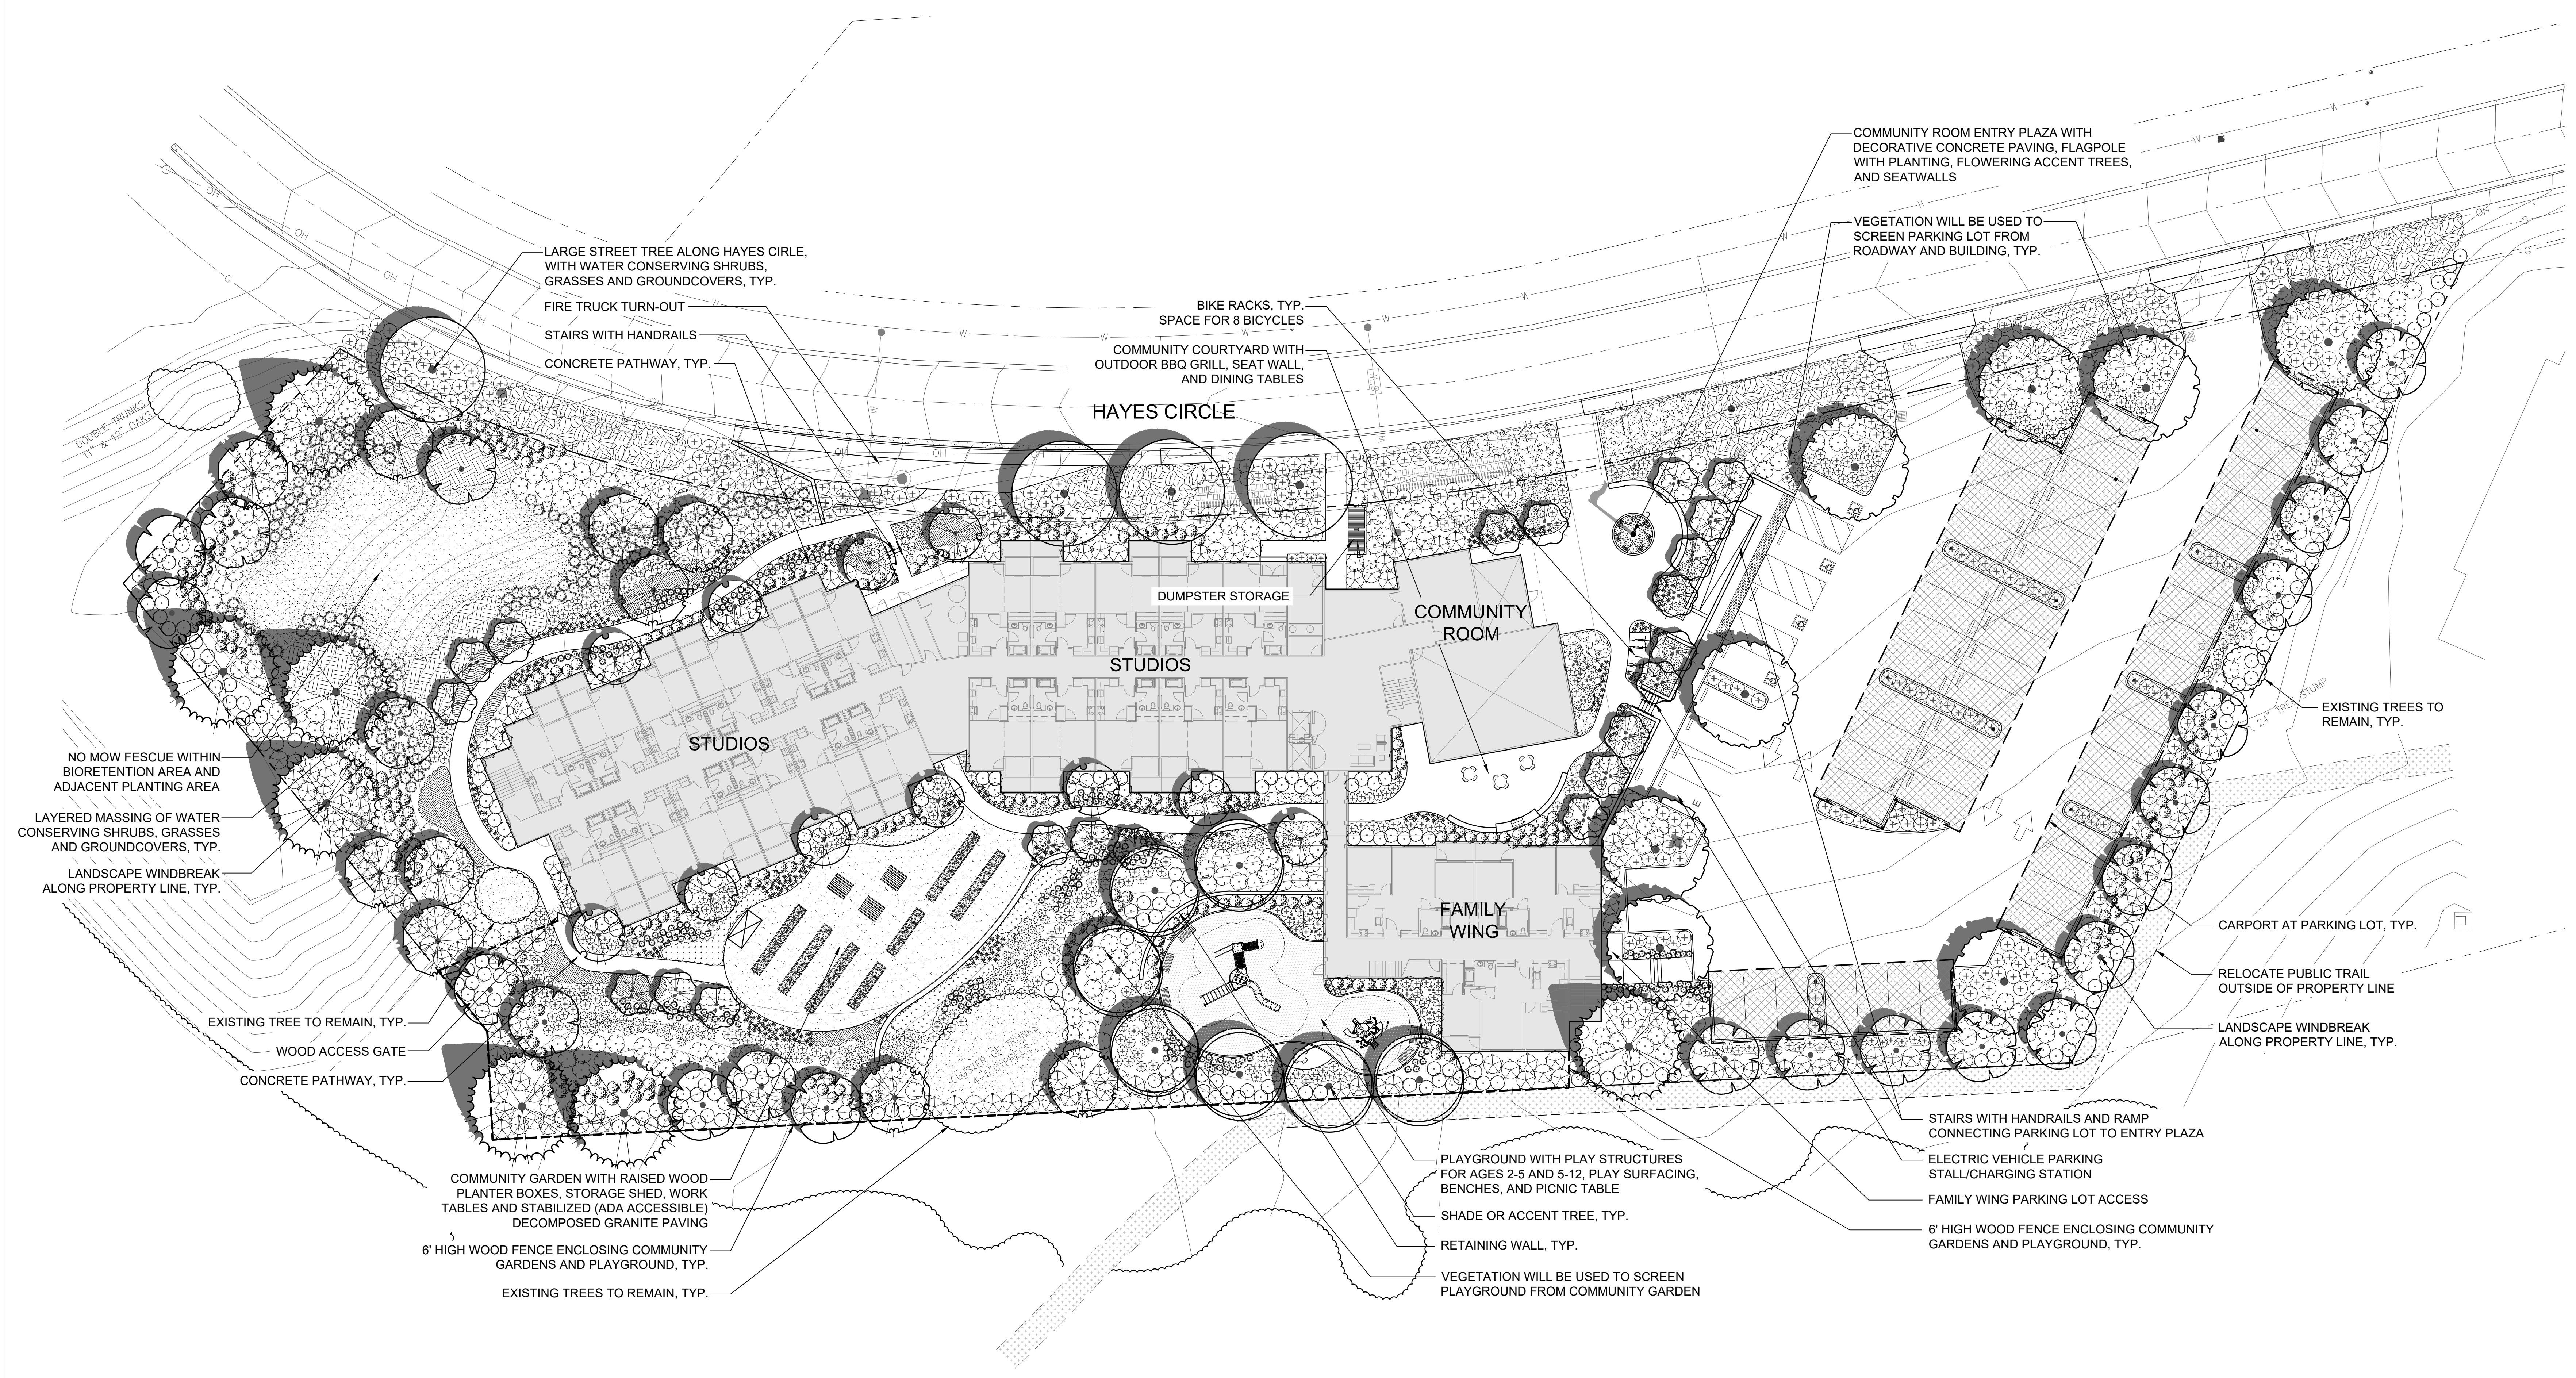

PLANTING DESIGN INTENT STATEMENT

The planting design utilizes a variety of plants to create layers of color and texture to compliment the architecture. Shade tolerant plants will be utilized on the North facing sides of the project and in covered spaces. The plants will be selected utilizing the State of California's Model Water Efficient Landscape Ordinance plant list and ET Calc water management computer software, as well as recommended plant sources from the Marina Coast Water District. See Sheet L2.1 for Plant Palette.

WATER USE DESIGN INTENT STATEMENT

The irrigation system will be a fully automatic, low gallon use drip system. This system will be designed to connect to the city's recycled water supply, when available. The low, medium and high water use hydrozones will be on separate valve circuits. All new trees will have separate drip or bubbler circuits. The remote control valves will have integral pressure regulators to prevent fluctuations and ensure constant application rates to minimize over or under watering. The electronic irrigation controller will be weather based and make automatic adjustments based on current climate along with multiple programs and application cycles/start times. A rain switch will be installed to prevent irrigation during rainy periods. A flow sensor and master valve will be connected to the controller to allow automatic shut off of any valve circuit or main line in the event of a pipe brake to prevent water waste.

VETERANS SUPPORTIVE HOUSING


MARINA, CALIFORNIA

JOB NO.	V1552
DRAWN	WM
CHECKED	SVD
JOB CAPTAIN	WM
DATE	12/21/2015
	DESIGN REVIEW APPLICATION
	1/26/2016
	DR RESUBMITTAL
	2/10/2016
	DR RESUBMITTAL

DRAWING TITLE
PRELIMINARY LANDSCAPE PLAN

SCALE 1"=20'-0"


PLANT PALETTE

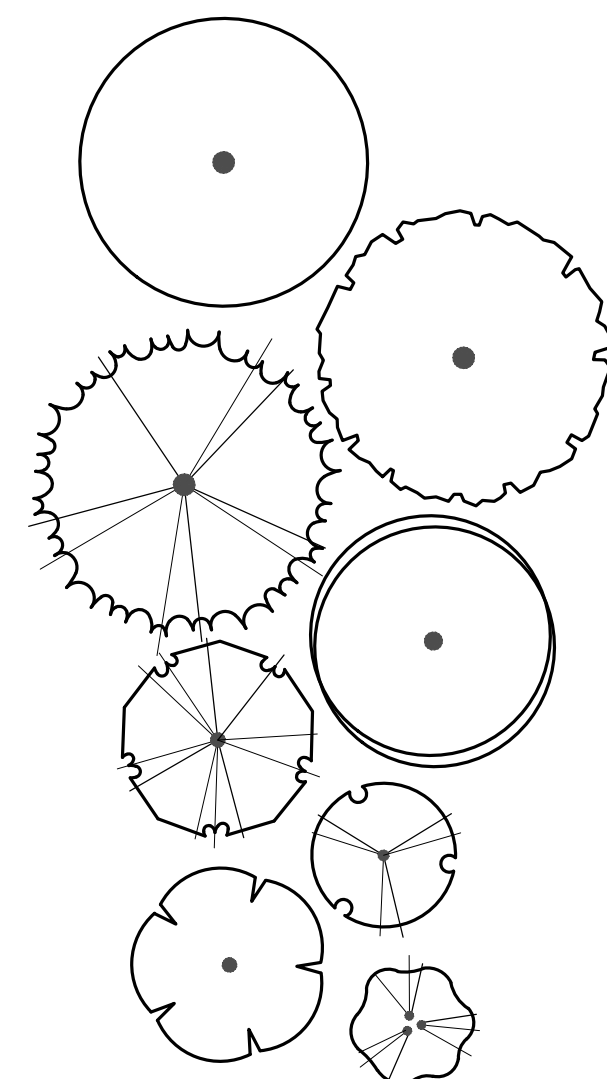

TREES

AESCULUS CALIFORNICA
 ALBIZIA JULIBRISSIN
 ARBUTUS MENZIESII
 ARBUTUS UNEDO
 CALOEDRUS DECURRENS
 CARPINUS BETULUS
 CATALPA SPECIOSA
 CEDRUS DEODARA
 CERCIS OCCIDENTALIS
 CRATAEGUS PHAENOPYRUM
 CUPRESSUS MACROCARPA
 ERIOBOTRYA JAPONICA
 GEJERA PARVIFOLIA
 GINKGO BILOBA
 GLEDITSIA TRIACANTHOS
 KOELREUTERIA PANICULATA
 LAURUS NOBILIS
 LYONOTHAMNUS FLORIBUNDUS
 MAYTENUS BOARIA
 MORUS ALBA 'STRIBLING'
 OLEA EUROPAEA
 PINUS COULTERI
 PINUS RADIATA
 PINUS THUNBERGII
 PISTACIA CHINENSIS
 PODOCARPUS GRACILIOR
 POPULUS FREMONTII
 PRUNUS CAROLINIANA
 QUERCUS AGRIFOLIA
 QUERCUS ILEX
 ROBINIA X AMBIGUA 'IDAHOENSIS'
 SCHINUS MOLLE
 SOPHORA JAPONICA
 UMBELLULARIA CALIFORNICA
 VITEX AGNUS-CASTUS
 X CHITALPA TASKENTENSIS

COMMON NAME	CONT
CALIFORNIA BUCKEYE	24" BOX
SILK TREE	24" BOX
MADRONE	24" BOX
STRAWBERRY TREE	15 GALLON
INCENSE CEDAR	24" BOX
EUROPEAN HORNBEAM	24" BOX
WESTERN CATALPA	24" BOX
DEODAR CEDAR	24" BOX
WESTERN REDBUD	15 GALLON
WASHINGTON THORN	15 GALLON
MONTEREY CYPRESS	24" BOX
LOQUAT	15 GALLON
AUSTRALIAN WILLOW	24" BOX
MAIDENHAIR TREE	24" BOX
HONEY LOCUST	24" BOX
GOLDEN RAIN TREE	24" BOX
GRECIAN LAUREL	15 GALLON
CATALINA IRONWOOD	15 GALLON
MAYTEN TREE	15 GALLON
WHITE MULBERRY	24" BOX
OLIVE	24" BOX
COULTER PINE	24" BOX
MONTEREY PINE	24" BOX
JAPANESE BLACK PINE	24" BOX
CHINESE PISTACHE	24" BOX
FERN PINE	24" BOX
FREMONT COTTONWOOD	24" BOX
CAROLINA LAUREL CHERRY	15 GALLON
COAST LIVE OAK	24" BOX
HOLLY OAK	24" BOX
IDAHO LOCUST	24" BOX
CALIFORNIA PEPPER TREE	24" BOX
JAPANESE PAGODA TREE	24" BOX
CALIFORNIA BAY	15 GALLON
CHASTE TREE	24" BOX
CHITALPA	24" BOX

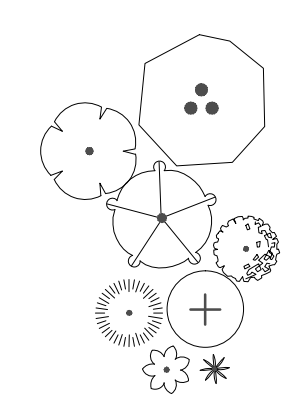

SHRUBS, GRASSES & GROUNDCOVERS

AEONIUM SPECIES
 AGAVE SPECIES
 ARCTOSTAPHYLOS SPECIES
 ARCTOTHECA CALENDULA
 ARCTOTIS SPECIES
 ATRIPLEX LENTIFORMIS BREWERI
 BACCHARIS PILULARIS 'TWIN PEAKS'
 CALLISTEMON 'LITTLE JOHN'
 CEANOTHUS GRISEAUS HORIZONTALIS
 CENOTHUS 'JOYCE COULTER'
 CERATOSTIGMA PLUMBAGINOIDES
 CHONDROPETALUM TECTORUM
 COPROSMA KIRKII 'VARIEGATA'
 CORREA PULCHELLA 'PINK FLAMINGO'
 COTONEASTER DAMMERI 'LOWFAST'
 DELOSPERMA ALBA
 DIANELLA TASMANICA 'SILVER STREAK'
 DROSNATHEMUM FLORIBUNDUM
 ECHEVERIA AGAVOIDES
 ERIGERON GLAUCUS
 ERIGONUM GIGANTEA
 ERYSIMUM AMMONPHILUM
 ESCHSCHOLZIA CALIFORNICA
 EURYOPS HYRIBID
 FESTUCA OVINA GLAUCA
 FESTUCA MAIREI
 GALVEZIA SPECIOSA
 GARRYA ELLIPTICA
 GAZANIA SPECIES
 GREVILLEA ROSMARINIFOLIA
 HAKEA SUAVEOLENS
 HELICTOTRICHON SEMPERVIRENS
 KNIPHOFIA UVARIA
 LANTANA MONTEVIDENSIS
 LAVATERA ASSURGENTIFOLIA
 LEPTOSPERMUM LAEVIGATUM 'COMPACTA'
 LIMONIUM PEREZII
 MAHONIA REPENS
 MUHLENBERGIA RIGENS
 MYOPORUM PARVIFOLIUM 'PROSTRATUM'
 NANDINA DOMESTICA
 NO MOW FINE FESCUE BLEND
 PHORMIUM TENAX
 PITTOSPORUM TOBIRA SPECIES
 PRUNUS CAROLINIANA 'BRIGHT 'N TIGHT'
 RHAMNUS CALIFORNICA 'SEAVIEW'
 RIBES SPECIOSUM
 RIBES VIBURNIFOLIUM
 ROSMARINUS OFFICINALIS
 SALVIA SPECIES
 SANTOLINA CHAMAECYPARISSUS
 SCAEVOLA 'MAUVE CLUSTERS'
 SEDUM SPECIES
 SISYRINCHIUM BELLUM
 SOLLYA HETEROPHYLLA
 TEUCRIUM FRUTICANS
 VIBURNUM TINUS
 WESTRINGIA ROSMARINIFORMIS
 XYLOSMA CONGESTUM 'COMPACTA'

COMMON NAME	CONT
CANARY ISLAND ROSE	1 GALLON
AGAVE	5 GALLON
MANZANITA	5 GALLON
CAPEWEED	1 GALLON
AFRICAN DAISY	1 GALLON
SALT BUSH	5 GALLON
DWARF COYOTE BUSH	5 GALLON
DWARF BOTTLEBRUSH	1 GALLON
CARMEL CREEPER	5 GALLON
JOYCE COULTER CEANOTHUS	5 GALLON
DWARF PLUMBAGO	1 GALLON
CAPE RUSH	1 GALLON
CREEPING MIRROR PLANT	1 GALLON
AUSTRALIAN FUCHSIA	5 GALLON
LOWFAST BEARBERRY COTONEASTER	1 GALLON
WHITE TRAILING ICE PLANT	1 GALLON
SILVER STREAK FLAX LILY	1 GALLON
MAGIC CARPET ICE PLANT	1 GALLON
WAX AGAVE	1 GALLON
SEASIDE DAISY	1 GALLON
GIANT BUCKWHEAT	1 GALLON
COAST WALLFLOWER	1 GALLON
CALIFORNIA POPPY	1 GALLON
YELLOW BUSH DAISY	1 GALLON
BLUE FESCUE	1 GALLON
ATLAS FESCUE	5 GALLON
ISLAND BUSH SNAPDRAGON	5 GALLON
COAST SILKTASSEL	5 GALLON
GAZANIA	1 GALLON
ROSEMARYGREVILLEA	5 GALLON
SWEET HAKEA	1 GALLON
BLUE OAT GRASS	1 GALLON
RED HOT POKER	1 GALLON
LANTANA	1 GALLON
TREE MALLOW	5 GALLON
DWARF TEA TREE	5 GALLON
STATICE	1 GALLON
CREEPING MAHONIA	1 GALLON
DEER GRASS	5 GALLON
MYOPORUM	1 GALLON
HEAVENLY BAMBOO	5 GALLON
SOD	5 GALLON
NEW ZEALAND FLAX	5 GALLON
WHEELER'S DWARF	5 GALLON
BRIGHT 'N TIGHT CAROLINA LAUREL	5 GALLON
DWARF COFFEE BERRY	5 GALLON
FUCHSIA FLOWERING GOOSEBERRY	5 GALLON
CATALINA CURRANT	5 GALLON
CREEPING ROSEMARY	5 GALLON
SAGE	5 GALLON
LAVENDER COTTON	5 GALLON
FAN FLOWER	1 GALLON
SEDUM	1 GALLON
BLUE-EYED GRASS	1 GALLON
AUSTRALIAN BLUEBELL	5 GALLON
BUSH GERMANDER	5 GALLON
LAURUSTINUS	5 GALLON
COAST ROSEMARY	5 GALLON
COMPACT XYLOSMA	5 GALLON

VETERANS SUPPORTIVE HOUSING

MARINA, CALIFORNIA

JOB NO.	V1552
DRAWN	WM
CHECKED	SVD
JOB CAPTAIN	WM
DATE	12/21/2015
	DESIGN REVIEW
	APPLICATION
	1/26/2016
	DR. RESUBMITTAL
	2/10/2016
	DR. RESUBMITTAL

DRAWING TITLE
PRELIMINARY PLANT PALETTE


SCALE N/A

IRRIGATION EQUIPMENT LIST


SYMBOL	MANUFACTURER/MODEL/DESCRIPTION	
	Rain Bird RWS-B-C-P Root Watering System with 4.0" diameter x 36.0" long with locking grate, semi-rigid mesh tube, purple grate, and check valve. Rain Bird bubbler option as indicated: 1401 0.25 gpm, 1402 0.5 gpm, 1404 1.0 gpm, 1408 2.0 gpm.	INSTALL ONE BUBBLER PER TREE.
	Drip Zone Control from PVC lateral to drip tubing manifold connection	NOTE: LOCATION DIAGRAMMATIC, SEE DRIP DETAILS FOR PVC LATERAL TO DRIP TUBING MANIFOLD CONNECTION.
	Area to Receive Dripline Toro RGP-212-E (12) 5/8" dia. Landscape Dripline with Purple Pipe and Rootguard Protection and 0.53gph emitters at 12" o.c. Dripline lateral rows spaced at 12" apart, with emitters offset for triangular pattern.	NOTE: TUBING INSTALLED BELOW GRADE, SEE DRIP DETAILS. FLUSH VALVE AND AIR RELIEF VALVES NOT SHOW ON PLANS FOR DESIGN CLARITY, SEE DRIP DETAILS FOR TYPICAL INSTALLATION LOCATIONS AT EACH DRIP CIRCUIT.
	Irritrol 700 with OMR-100 Electric Remote Control Valve, with Omni-Reg 5-100psi regulator	SET PRESSURE REGULATORS AT 35 PSI.
	Rain Bird 33-DNP 3/4" Brass Quick-Coupling Valve, with Corrosion-Resistant Stainless Steel Spring, Locking Thermoplastic Non-Potable Purple Rubber Cover, and 2-Piece Body.	
	Nibco T-113-LF Lead Free Class 125 bronze gate shut off valve with wheel handle, same size as mainline pipe diameter at valve location. Size Range - 1/4" - 3"	
	Griswold 2160MRE 2-1/2" 2-1/2" Solenoid, Normally Open Master Valve. Epoxy Coating and Purple Handle for Reclaimed Water. Cast Iron and Bronze Material. NPT End Connection.	
	500XL-YSBR Lead Free Pressure Reducing Valve.	
	Febco LF825Y 2" Lead Free Reduced Pressure Backflow Preventer.	
	Irritrol MC-24-E 24 Station, Commercial-Grade, Outdoor/Indoor Controller. Equipped in a rugged, lockable, vandal-proof, weather resistant steel cabinet. Install in Irritrol P-6B Pedestal. Install Climate Logic receiver unit in P-6B Pedestal.	
	Irritrol CL Wireless Weather Sensing System. 100-Receive and Transmitter Kit. Outdoor sensor, and receiver attaches to Irritrol Controller. Compatible with Rain Dial-R, Total Control-R, Kwikdial, and MC-E controllers. Monitors weather data.	FOR MOUNTING INFO, SEE NOTES ON PLANS
	Irritrol FS-B150 1-1/2" Flow Sensor	
	Dig P Series 2" Y-Filter with 150 mesh stainless steel screen.	Y-FILTER TO BE INSTALLED ON MAIN LINE AS SHOWN.
	Amiad 150 mesh Y-Filter with flush valve, or approved equivalent. Select filter size with gpm flow rate compatible with valve circuit gpm flow rate.	Y-FILTER TO BE INSTALLED AT ALL CIRCUITS.
	Water Meter 1-1/2"	NOTE: SEE P.O.C. NOTES ON IRRIGATION PLANS.
	Irrigation Lateral Line: PVC Class 200 SDR 21 Purple colored pipe with continuous wording "Caution - Recycled Water-Do Not Drink" printed on both sides of pipe, install pipe with wording facing upwards, with solvent weld Sch.40 fittings. Only lateral transition pipe sizes 1" and above are indicated on the plan, with all others being 3/4" in size. 12" min. bury.	
	Irrigation Mainline: PVC Schedule 40 and Class 315 Purple colored pipe with continuous wording "Caution - Recycled Water-Do Not Drink" printed on both sides of pipe, install pipe with wording facing upwards, with solvent weld Sch.40 fittings. PVC Schedule 40 to 1-1/2", PVC Class 315 SDR 13.5 for pipes 2" and larger. 2-1/2" & smaller: 18" min. bury; 3" & larger 24" min. bury.	
	Pipe Sleeve: PVC Class 315 SDR 13.5 Purple colored pipe. Pipe sleeve size shall allow for irrigation piping and their related couplings to easily slide through sleeving material. Extend sleeves 18 inches beyond edges of paving or construction. 24" min. bury.	NOTE: PURPLE PIPE SLEEVES SHALL HAVE CONTINUOUS WORDING "CAUTION - RECYCLED WATER" PRINTED ON BOTH SIDES OF PIPE. INSTALL PIPE WITH WORDING FACING UPWARDS. FOR SLEEVES UNDER ROADS, SEE SLEEVE AT ROADS DETAIL.
	Valve Callout: Valve Number, Valve Flow, Valve Size	
	Sch. 80 Electrical Conduit, 24" min. bury.	

IRRIGATION CONTROLLER NOTES:


- IRRIGATION CONTROLLER RUN TIMES ARE NOT INCLUDED ON LANDSCAPE PLANS. IRRIGATION CONTROLLERS ARE ET BASED SMART CONTROLLERS THAT GENERATE OPTIMUM RUN TIME SCHEDULES BASED UPON LOCAL WEATHER CONDITIONS.
- CONTROLLER IS INITIALLY PROGRAMMED WITH IRRIGATION SYSTEM COMPONENT INFORMATION, PLANT MATERIAL WATER USE REQUIREMENTS, SOIL TYPE, AND LOCAL MICRO CLIMATIC INFORMATION. CONTROLLER AUTOMATICALLY GENERATES RUN TIME SCHEDULES FROM THIS INFORMATION. EACH DAY CONTROLLER RECEIVES LOCAL WEATHER CONDITION DATA (VIA WIRELESS CONNECTION), AND AUTOMATICALLY ADJUST IT'S WATERING SCHEDULE FOR OPTIMUM WATER CONSERVATION.
- CONTRACTOR SHALL PROGRAM CONTROLLER'S FLOW MONITORING FEATURE TO DETECT FLOWS OF 5 GPM ABOVE PEAK RECORDED GPM FLOW FOR MAIN LINE AND LATERAL LINES/RCVS. CONTROLLER SHALL BE SET TO SHUT MASTER VALVE AND CONTROLLER OFF IN THE EVENT OF AN OVERFLOW CONDITION (MAIN LINE OR LATERAL LINE BREAK).

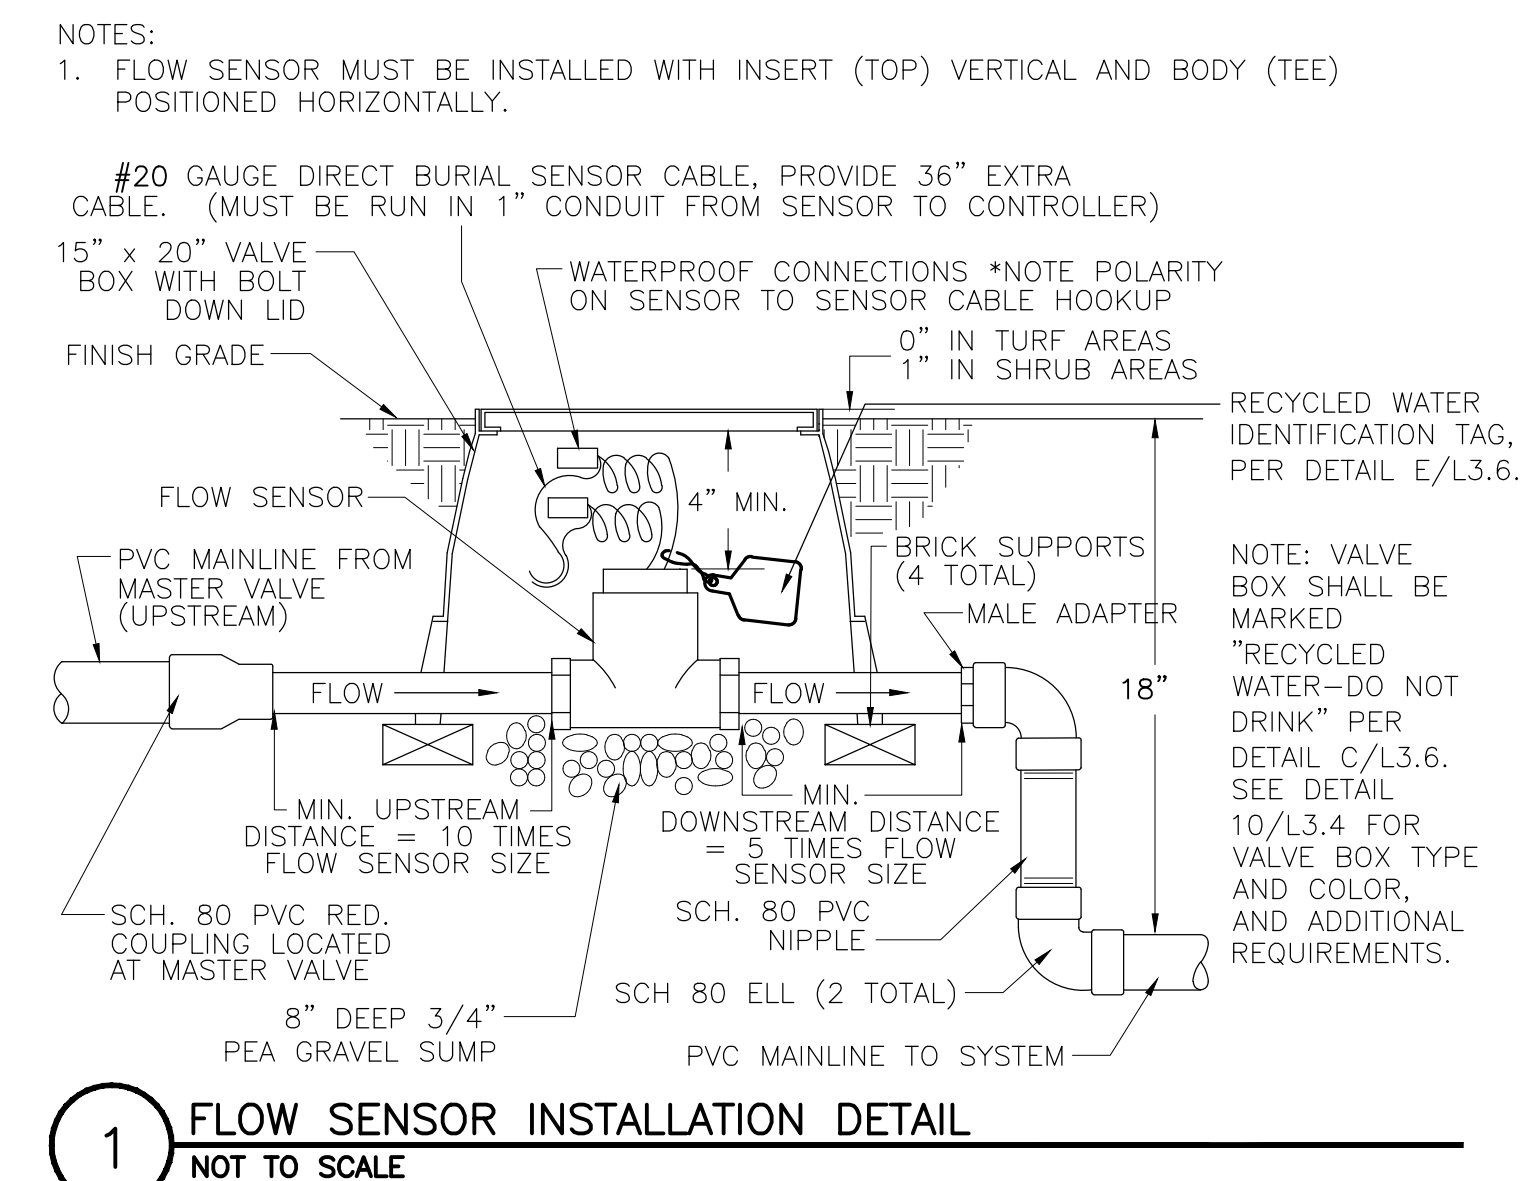


1 FLOW SENSOR INSTALLATION DETAIL
 NOT TO SCALE

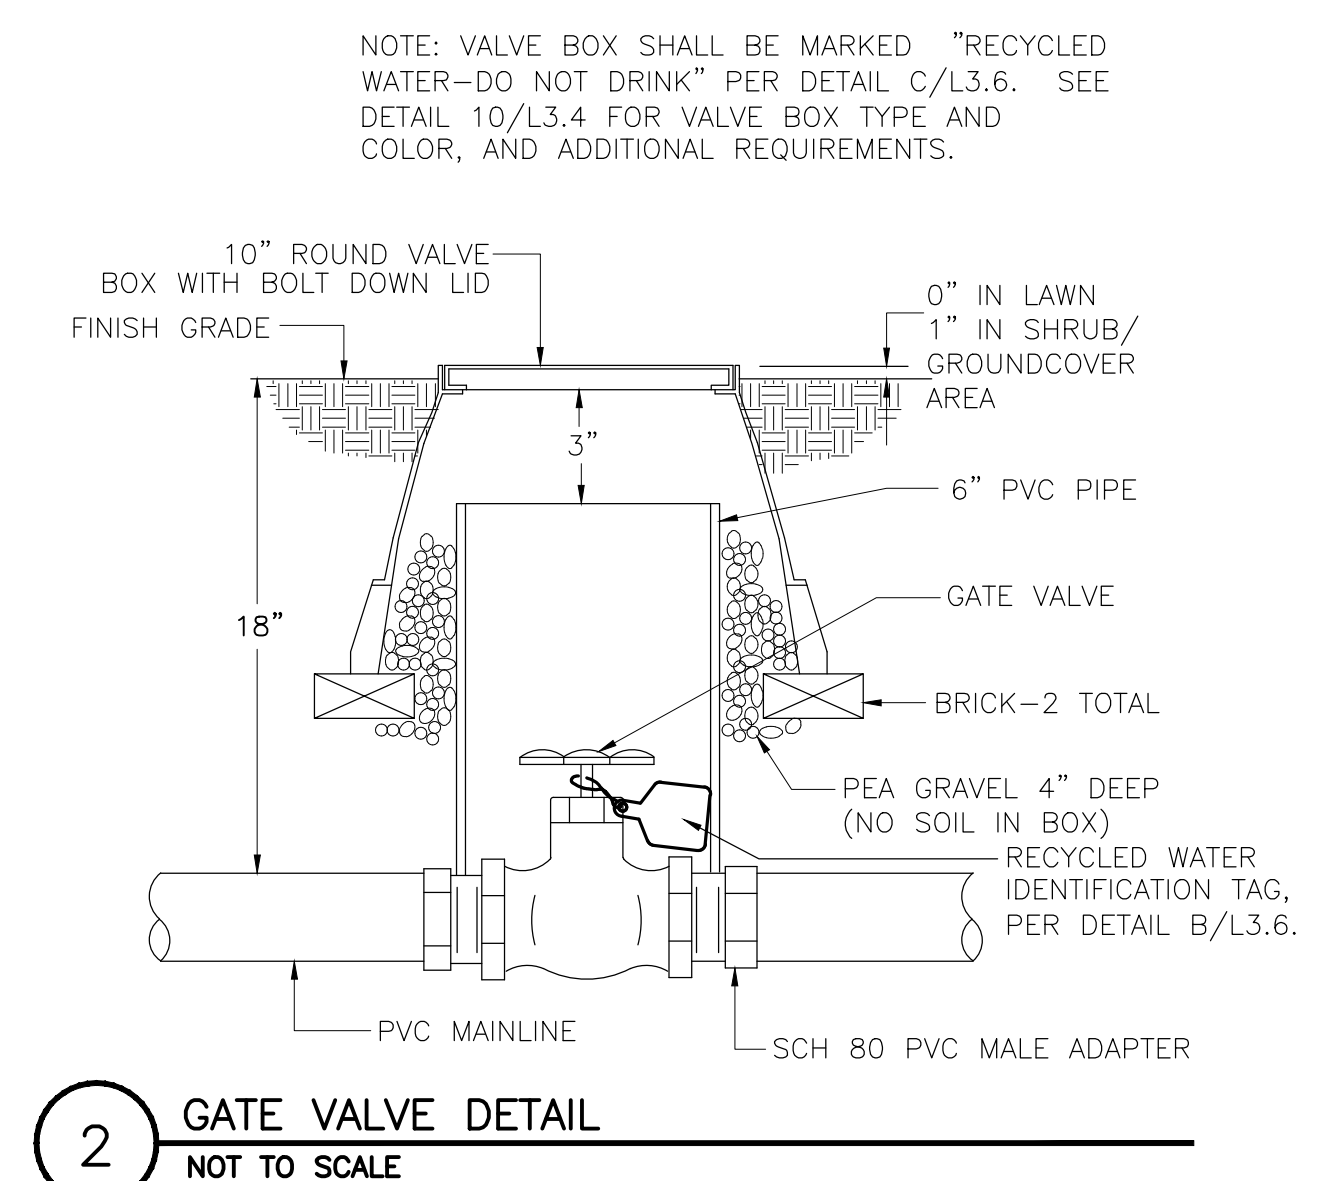


2 GATE VALVE DETAIL
 NOT TO SCALE

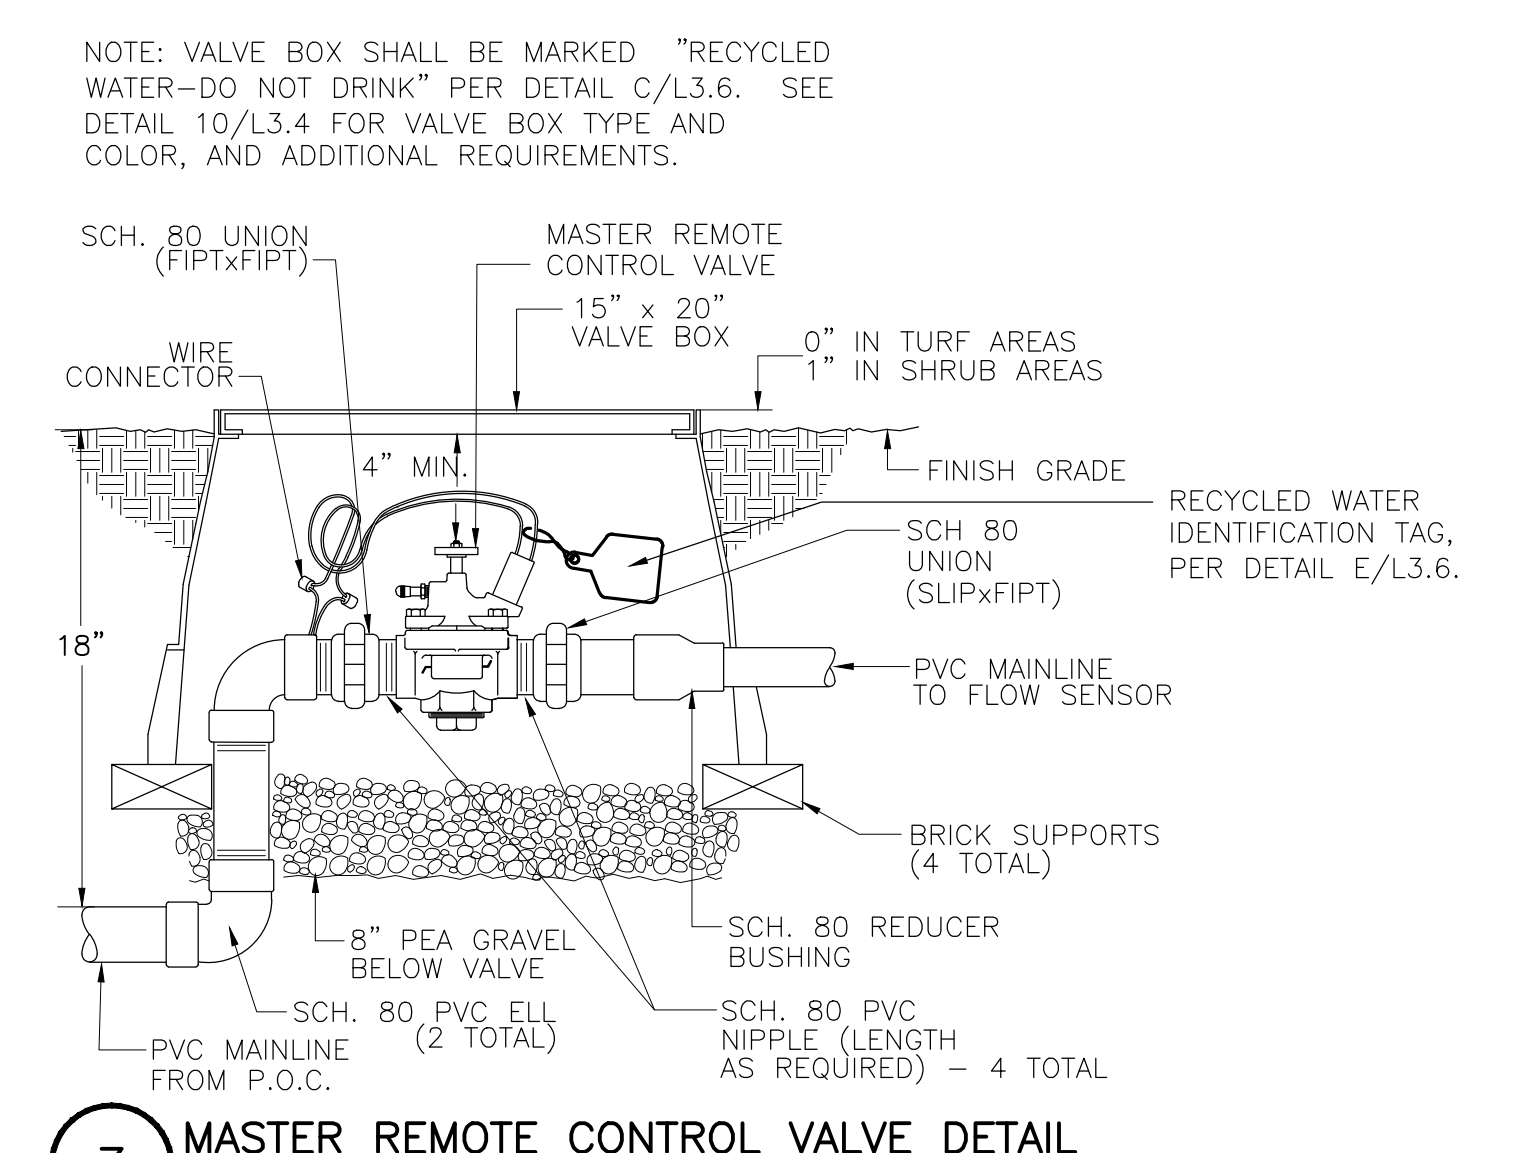


3 MASTER REMOTE CONTROL VALVE DETAIL
 NOT TO SCALE

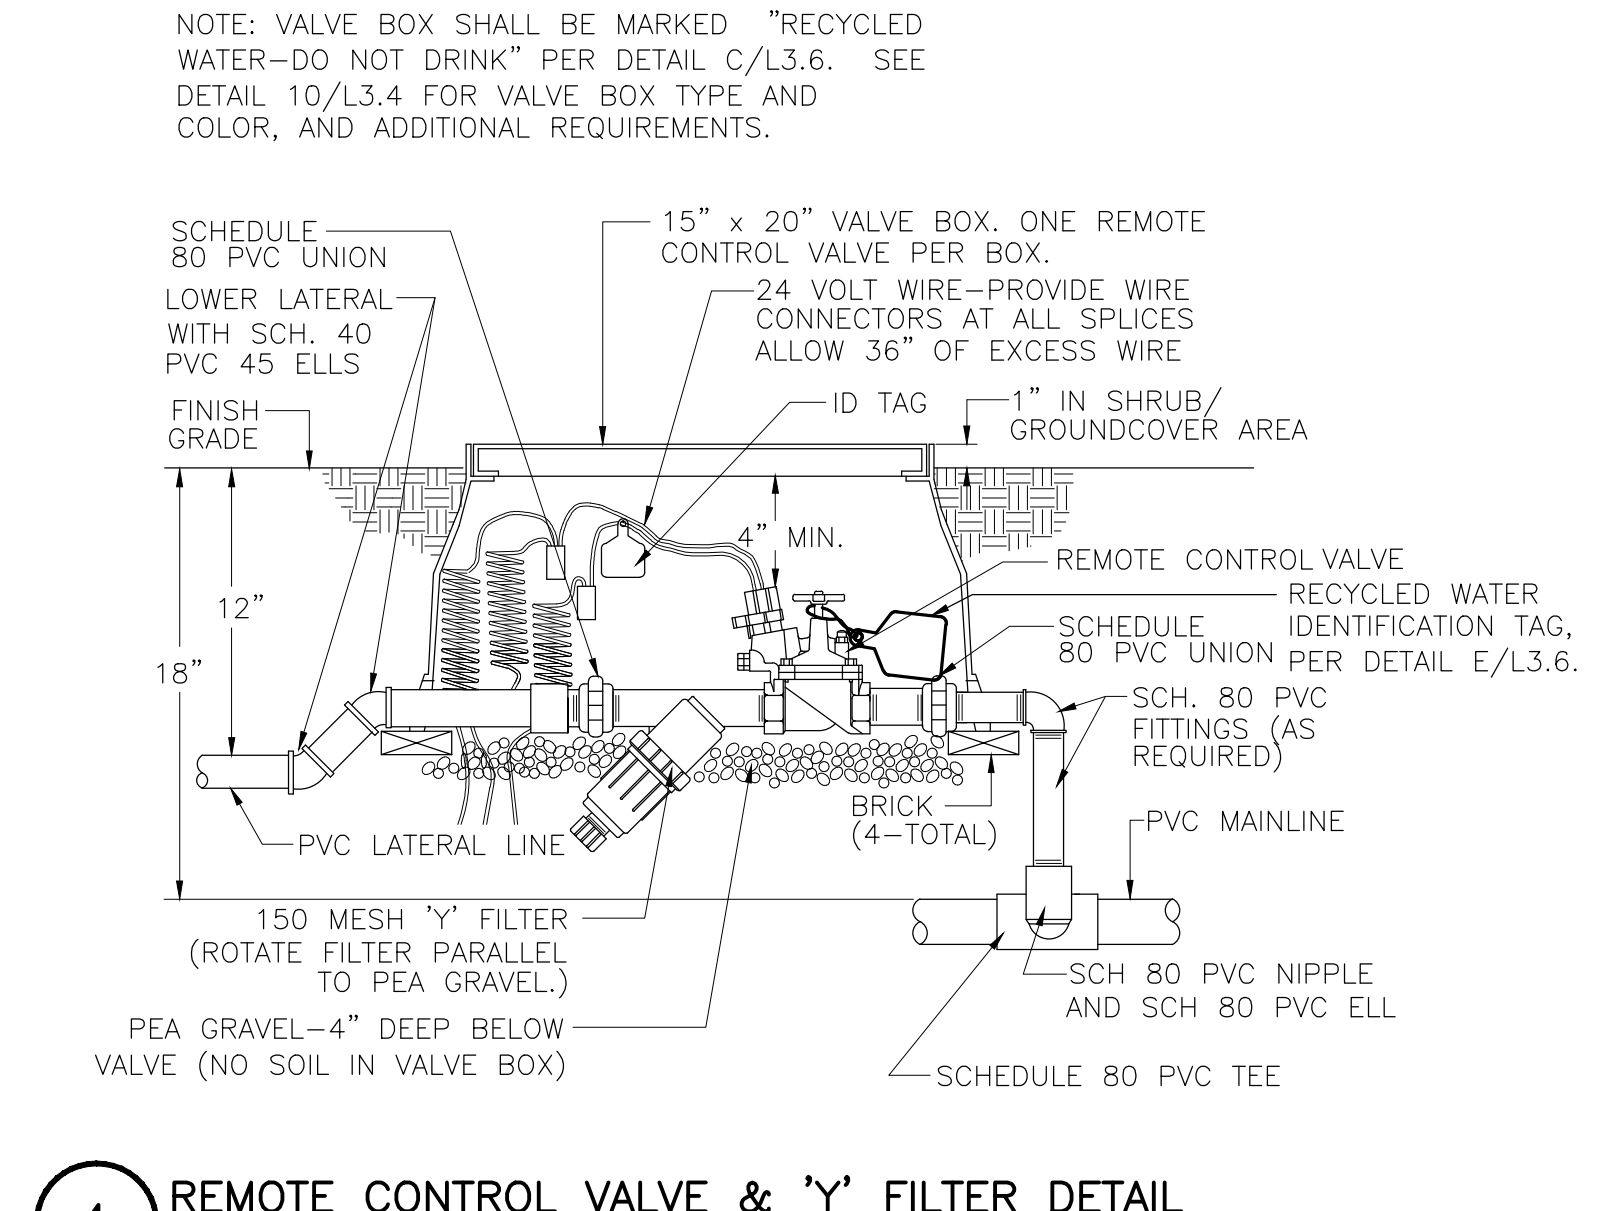

4 REMOTE CONTROL VALVE & Y FILTER DETAIL
 NOT TO SCALE

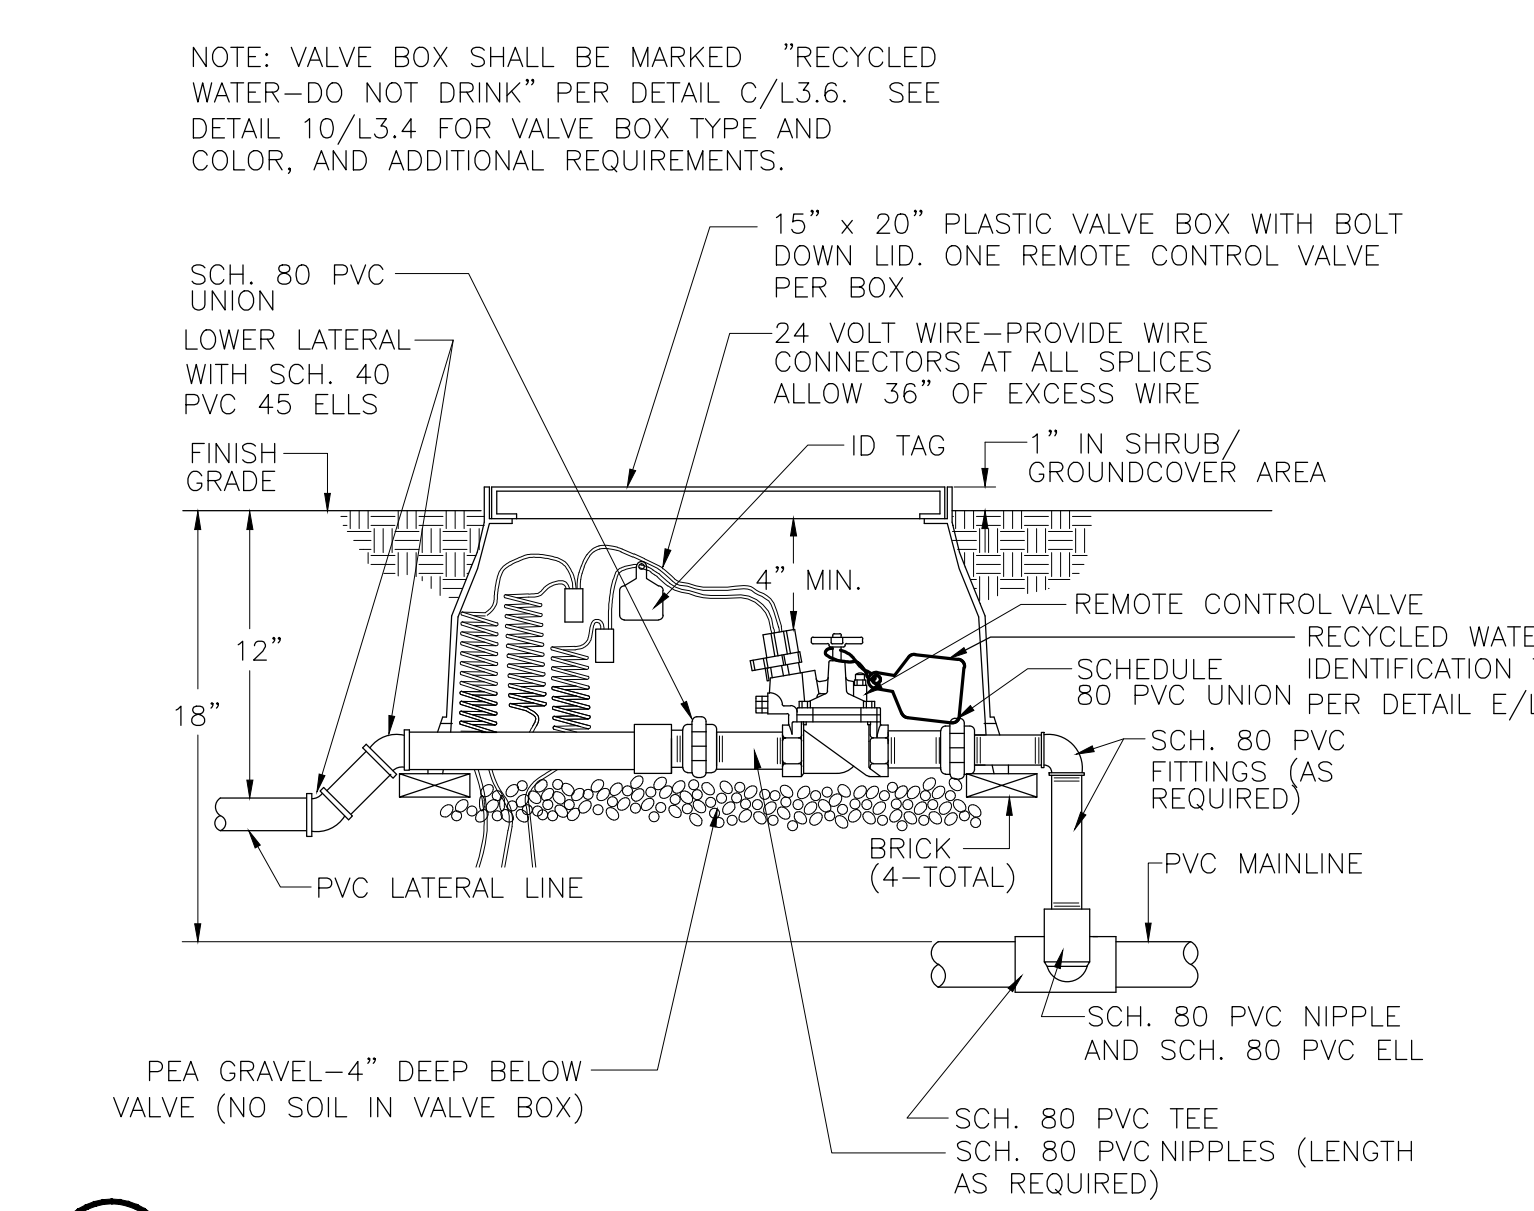

5 REMOTE CONTROL VALVE DETAIL
 NOT TO SCALE

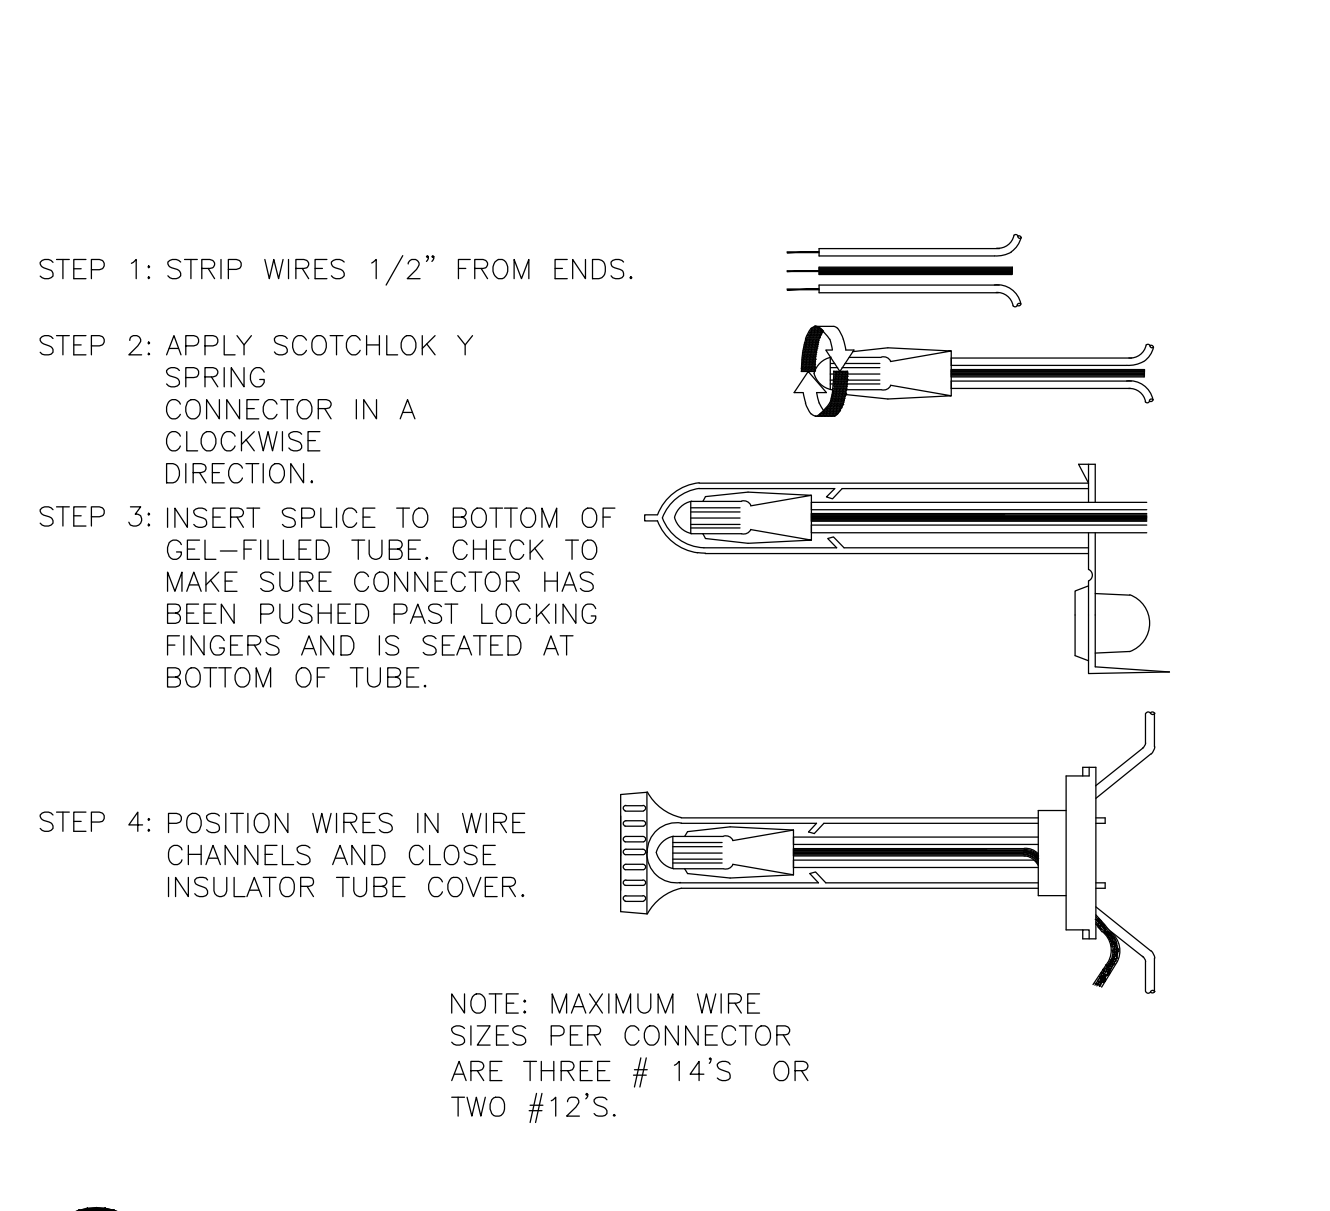

6 WIRE CONNECTION DETAIL
 NOT TO SCALE


VETERANS SUPPORTIVE HOUSING

MARINA, CALIFORNIA

JOB NO.	V1552
DRAWN	WM
CHECKED	SVD
JOB CAPTAIN	WM
DATE	12/21/2015
	DESIGN REVIEW APPLICATION
	1/26/2016
	DR RESUBMITTAL
	2/10/2016
	DR RESUBMITTAL

IRRIGATION EQUIPMENT LIST AND DETAILS

SCALE NTS

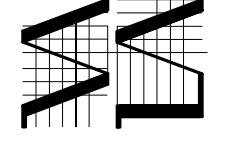

TORO

TORO-IRRIGATION DIVISION
 5825 JASMINE STREET
 RIVERSIDE, CA 92504
 TOLL FREE: 1-877-345-8676
 PHONE: (951) 785-3152
 FAX: (951) 359-1870
 www.toro.com

LEGEND

- 1" ABOVE FINISH GRADE.
- NATIVE SOIL PER SPECIFICATIONS.
- FINISH GRADE.
- TORO DL2000 FLUSH VALVE (FCH-H-FPT).
- 6" ROUND PLASTIC VALVE BOX - HEAT BRAND "AR" ON LID IN 1" HIGH CHARACTERS.
- 3/4" SCH 80 PVC NIPPLE (LENGTH AS REQUIRED).
- BRICK SUPPORTS (2 COMMON BRICKS REQUIRED).
- PEA GRAVEL SUMP (6" x 18").
- PVC TEE (S&ST) WITH 3/4" THREADED OUTLET.
- PVC PIPING.

NOTE:
 USE ONE FLUSH VALVE FOR EVERY 7 GPM PER ZONE. LOCATE AT LOW POINTS. FLUSH RATE IS 0.8 GPM. FLUSH PRESSURE IS 2 PSI. REFER TO TORO PUBLICATION #ALT111 FOR SPECIFICATIONS.

SECTION/ELEVATION
 NOT TO SCALE

NOTES:
 1. INSTALLATION TO BE COMPLETED IN ACCORDANCE WITH MANUFACTURERS SPECIFICATIONS.
 2. DO NOT SCALE DRAWINGS.
 3. CONTRACTORS NOTE: FOR PRODUCT AND COMPANY INFORMATION VISIT www.CADetails.com/info REFERENCE NUMBER 065-188x.

1 DRIP CIRCUIT FLUSH VALVE DETAIL
 NOT TO SCALE

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LEGEND

- 1" ABOVE FINISH GRADE.
- NATIVE SOIL PER SPECIFICATIONS.
- FINISH GRADE.
- TORO DL2000 ARVACUUM RELIEF VALVE (YD-500-34).
- 1/2" PVC COUPLING (T&T).
- 6" ROUND PLASTIC VALVE BOX - HEAT BRAND "AR" ON LID IN 1" HIGH CHARACTERS.
- 1/2" SCH 80 PVC NIPPLE (LENGTH AS REQUIRED).
- BRICK SUPPORTS (2 COMMON BRICKS REQUIRED).
- PEA GRAVEL SUMP (6" DEEP).
- PVC ELL (S&T) WITH 1/2" THREADED OUTLET.
- PVC PIPING.

NOTE:
 USE ONE AIRRELIEF VALVE FOR EVERY 7 GPM PER ZONE. LOCATE AT HIGH POINTS. REFER TO TORO PUBLICATION #ALT111 FOR SPECIFICATIONS.

SECTION/ELEVATION
 NOT TO SCALE

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2 DRIP CIRCUIT AIR VACUUM RELIEF VALVE DETAIL
 NOT TO SCALE

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 5825 JASMINE STREET
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LEGEND

- FINISH GRADE.
- TORO DL2000 DRIFLINE LATERAL.
- TORO LOC-EZE TEE (FT16).
- TORO BLUE STRIPE POLY TUBING
- TORO LOC-EZE X 1/2" MPT ADAPTER (FAM16).
- PVC TEE (S&ST) WITH 1/2" FPT OUTLET.
- NATIVE SOIL BACKFILL PER SPECIFICATIONS.
- DEPTH OF TUBING 3'-4"
- DEPTH OF PVC SUPPLY LINE 12"

DL2000 DRIFLINE:
 RPQ212(12)-5/8" DIA. TUBING WITH 0.53GPH EMITTERS AT 12" O.C.

SECTION/ELEVATION
 NOT TO SCALE

NOTES:
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3 DRIP CIRCUIT FEED MANIFOLD CONNECTION DETAIL
 NOT TO SCALE

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LEGEND

- TORO DL2000 AUTOMATIC FLUSH VALVE (FCH-H-FPT) PLUMBED TO FLUSH MANIFOLD AT LOW POINT.
- PVC FLUSH MANIFOLD.
- TORO DL2000 OPERATION INDICATOR (DL-MP9), OPTIONAL.
- TORO DL2000 MANFOLD-TO-ELBOW CONNECTION (TYP).
- TORO DL2000 DRIFLINE LATERAL (RGP-XXX-XX).
- AREA PERIMETER.
- PERIMETER LATERALS 2" TO 4" FROM EDGE.
- PVC LATERAL LINE FROM DRIP ZONE KIT.
- TORO LOC-EZE TEE (FT16).
- PVC SUPPLY MANIFOLD.
- TORO DL2000 ARVACUUM RELIEF VALVE (YD-500-34) PLUMBED TO SUPPLY MANIFOLD AT HIGH POINT.

DL2000 DRIFLINE:
 RPQ212(12)-5/8" DIA. TUBING WITH 0.53GPH EMITTERS AT 12" O.C.

NOTE:
 THE TOTAL LENGTH OF ALL INTERCONNECTED DRIP LINE SHALL NOT EXCEED THE MAXIMUM RUN LENGTH. SEE TORO SUBSURFACE IRRIGATION DESIGN GUIDE (FORM #ALT111).

PLAN
 NOT TO SCALE

NOTES:
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4 DRIP CIRCUIT ODD SHAPE LAYOUT - END FEED DETAIL
 NOT TO SCALE

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LEGEND

- PVC LATERAL LINE FROM DRIP ZONE KIT.
- TORO DL2000 ARVACUUM RELIEF VALVE (YD-500-34) PLUMBED TO PVC FLUSH MANIFOLD AT HIGH POINT.
- PVC FLUSH MANIFOLD.
- INLINE SPRING CHECK VALVE (SRS05) TO HELP CONTROL LOW-HEAD DRAINAGE (TYP) INSTALL AT EVERY 10' OF ELEVATION CHANGE.
- TORO DL2000 ARVACUUM RELIEF VALVE (YD-500-34) PLUMBED TO PVC FLUSH MANIFOLD JUST BELOW EACH CHECK VALVE (TYP).
- TORO DL2000 DRIFLINE LATERAL (RGP-XXX-XX).
- PVC SUPPLY MANIFOLD.
- TORO DL2000 MANFOLD-TO-ELBOW CONNECTION (TYP).
- TORO DL2000 OPERATION INDICATOR (DL-MP9), OPTIONAL.
- AREA PERIMETER.
- TORO DL2000 AUTOMATIC FLUSH VALVE (FCH-H-FPT) PLUMBED TO FLUSH MANIFOLD AT LOW POINT.
- DL2000 DRIFLINE: RPQ212(12)-5/8" DIA. TUBING WITH 0.53GPH EMITTERS AT 12" O.C.

NOTE:
 THE TOTAL LENGTH OF ALL INTERCONNECTED DRIP LINE SHALL NOT EXCEED THE MAXIMUM RUN LENGTH. SEE TORO SUBSURFACE IRRIGATION DESIGN GUIDE (FORM #ALT111).

PLAN
 NOT TO SCALE

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5 DRIP CIRCUIT LAYOUT - SLOPE DETAIL

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LEGEND

- PVC LATERAL LINE FROM DRIP ZONE KIT.
- PVC SUPPLY MANIFOLD.
- TORO DL2000 MANFOLD-TO-ELBOW CONNECTION (TYP).
- TORO DL2000 DRIFLINE LATERAL (RGP-XXX-XX).
- TORO DL2000 ARVACUUM RELIEF VALVE (YD-500-34) PLUMBED TO TORO BLUE STRIPE POLY TUBING (EHD1645-XXX) AT EACH HIGH POINT.
- ARVACUUM RELIEF LATERAL, TORO BLUE STRIPE POLY TUBING (EHD1645-XXX) CENTERED ON MOUND OR BERM.
- PVC FLUSH MANIFOLD.
- PERIMETER LATERALS 2" TO 4" FROM EDGE.
- AREA PERIMETER.
- TORO DL2000 OPERATION INDICATOR (DL-MP9), OPTIONAL.
- TORO DL2000 AUTOMATIC FLUSH VALVE (FCH-H-FPT) PLUMBED TO FLUSH MANIFOLD AT LOW POINT.
- DL2000 DRIFLINE: RPQ212(12)-5/8" DIA. TUBING WITH 0.53GPH EMITTERS AT 12" O.C.

NOTE:
 THE TOTAL LENGTH OF ALL INTERCONNECTED DRIP LINE SHALL NOT EXCEED THE MAXIMUM RUN LENGTH. SEE TORO SUBSURFACE IRRIGATION DESIGN GUIDE (FORM #ALT111).

PLAN
 NOT TO SCALE

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6 DRIP CIRCUIT LAYOUT - END FEED DETAIL

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LEGEND

- TORO DL2000 AUTOMATIC FLUSH VALVE (FCH-H-FPT) PLUMBED TO FLUSH MANIFOLD AT LOW POINT.
- PVC FLUSH MANIFOLD.
- TORO DL2000 MANFOLD-TO-ELBOW CONNECTION (TYP).
- PVC LATERAL LINE FROM DRIP ZONE KIT.
- PVC SUPPLY MANIFOLD.
- TORO DL2000 MANFOLD-TO-TEE CONNECTION.
- TORO DL2000 DRIFLINE LATERAL (RGP-XXX-XX).
- ARVACUUM RELIEF LATERAL, TORO BLUE STRIPE POLY TUBING (EHD1645-XXX) CENTERED ON MOUND OR BERM.
- TORO DL2000 ARVACUUM RELIEF VALVE (YD-500-34) PLUMBED TO TORO BLUE STRIPE POLY TUBING (EHD1645-XXX) AT EACH HIGH POINT.
- PERIMETER LATERALS 2" TO 4" FROM EDGE.
- AREA PERIMETER.
- TORO DL2000 OPERATION INDICATOR (DL-MP9), OPTIONAL.
- DL2000 DRIFLINE: RPQ212(12)-5/8" DIA. TUBING WITH 0.53GPH EMITTERS AT 12" O.C.

NOTE:
 THE TOTAL LENGTH OF ALL INTERCONNECTED DRIP LINE SHALL NOT EXCEED THE MAXIMUM RUN LENGTH. SEE TORO SUBSURFACE IRRIGATION DESIGN GUIDE (FORM #ALT111).

PLAN
 NOT TO SCALE

NOTES:
 1. INSTALLATION TO BE COMPLETED IN ACCORDANCE WITH MANUFACTURERS SPECIFICATIONS.
 2. DO NOT SCALE DRAWINGS.
 3. CONTRACTORS NOTE: FOR PRODUCT AND COMPANY INFORMATION VISIT www.CADetails.com/info REFERENCE NUMBER 065-188x.

7 DRIP CIRCUIT LAYOUT - CENTER FEED DETAIL

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TUBING LAYOUT CHART NOTES:

- CONTRACTOR SHALL FIELD LAYOUT DRIP TUBING ZONE AREAS AS INDICATED ON THE PLANS, AND FIELD VERIFY/CALCULATE EACH ZONES TOTAL GPM DOES NOT EXCEED THE DRIP ZONE VALVE CIRCUIT GPM'S SHOWN ON THE PLANS. IF DRIP ZONE(S) GPM'S EXCEED GPM'S SHOWN ON PLANS, CONTRACTOR SHALL SPLIT DRIP ZONE(S) INTO TWO OR MORE DRIP ZONE VALVE CIRCUITS AREAS TO REDUCE GPM FLOW RATES AS NECESSARY.
- PSI AVAILABLE AT EACH DRIP CIRCUIT'S TUBING WILL VARY AND DEPEND UPON PSI AT WATER METER/P.O.C. AND PSI LOSSES FROM P.O.C TO DRIP TUBING REMOTE CONTROL VALVE. CONTRACTOR SHALL FIELD VERIFY PSI AVAILABLE AT EACH DRIP CIRCUIT'S VALVE, AND SELECT THE APPROPRIATE MAXIMUM TUBING LENGTH RUN FROM CHART BELOW. DO NOT EXCEED MAXIMUM TUBING RUN LENGTHS.
- WHERE NECESSARY, INSTALL ADDITIONAL PVC LATERAL SUPPLY MANIFOLDS IN DRIP ZONE AREAS TO KEEP TUBING RUN LENGTHS FROM EXCEEDING MAXIMUM RUN LENGTHS.
- PVC LATERAL SUPPLY MANIFOLDS SHALL BE SAME SIZE AS LATERAL LINE SIZE THAT FEEDS ENTIRE DRIP ZONE AREA.

TORO DRIP TUBING MAXIMUM LENGTH OF RUN CHART:

TUBING TYPE: TORO RGP-212(12); 5/8" DIA. TUBING WITH 0.53 GPH EMITTERS AT 12" O.C.

Performance Specifications (continued)	Maximum length of run
- RGP-212-XX:	
	250' @ 15 psi (76m @ 1.03 Bar)
	360' @ 25 psi (110m @ 1.72 Bar)
	400' @ 30 psi (122m @ 2.07 Bar)
	460' @ 40 psi (140m @ 2.76 Bar)

NOTES:
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 3. CONTRACTORS NOTE: FOR PRODUCT AND COMPANY INFORMATION VISIT www.CADetails.com/info REFERENCE NUMBER 065-188x.

8 DRIP CIRCUIT MAXIMUM TUBING LENGTH CHART
 NOT TO SCALE

DRIP CIRCUIT NOTES (FOR DETAILS 1-7):


- ALL DRIP TUBING SHALL BE INSTALLED 3"-4" BELOW GRADE.
- ALL PVC LATERALS LINES, INCLUDING PVC FEED LINES SHALL BE INSTALLED 12" BELOW GRADE.
- SEE IRRIGATION LEGEND FOR TUBING SPECIFICATIONS.
- SEE NOTES AT EACH DRIP DETAIL FOR ADDITIONAL REQUIREMENTS.
- CONTACT CHRIS STEELE, TORO IRRIGATION SPECIFICATION SALES MANAGER, 559-779-8676, PRIOR TO INSTALLATION OF DRIP TUBING TO REVIEW INSTALLATION REQUIREMENTS.

VETERANS SUPPORTIVE HOUSING

MARINA, CALIFORNIA

JOB NO. V1552
 DRAWN WM
 CHECKED SVD
 JOB CAPTAIN WM
 DATE 12/21/2015
 DESIGN REVIEW APPLICATION
 1/26/2016
 DR RESUBMITTAL
 2/10/2016
 DR RESUBMITTAL

DRAWING TITLE
IRRIGATION DETAILS

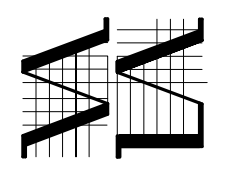

VETERANS SUPPORTIVE HOUSING


MARINA, CALIFORNIA

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DRAWING TITLE
IRRIGATION DETAILS


SCALE NTS

L3.3
CONCEPTS • DESIGN • ARCHITECTS

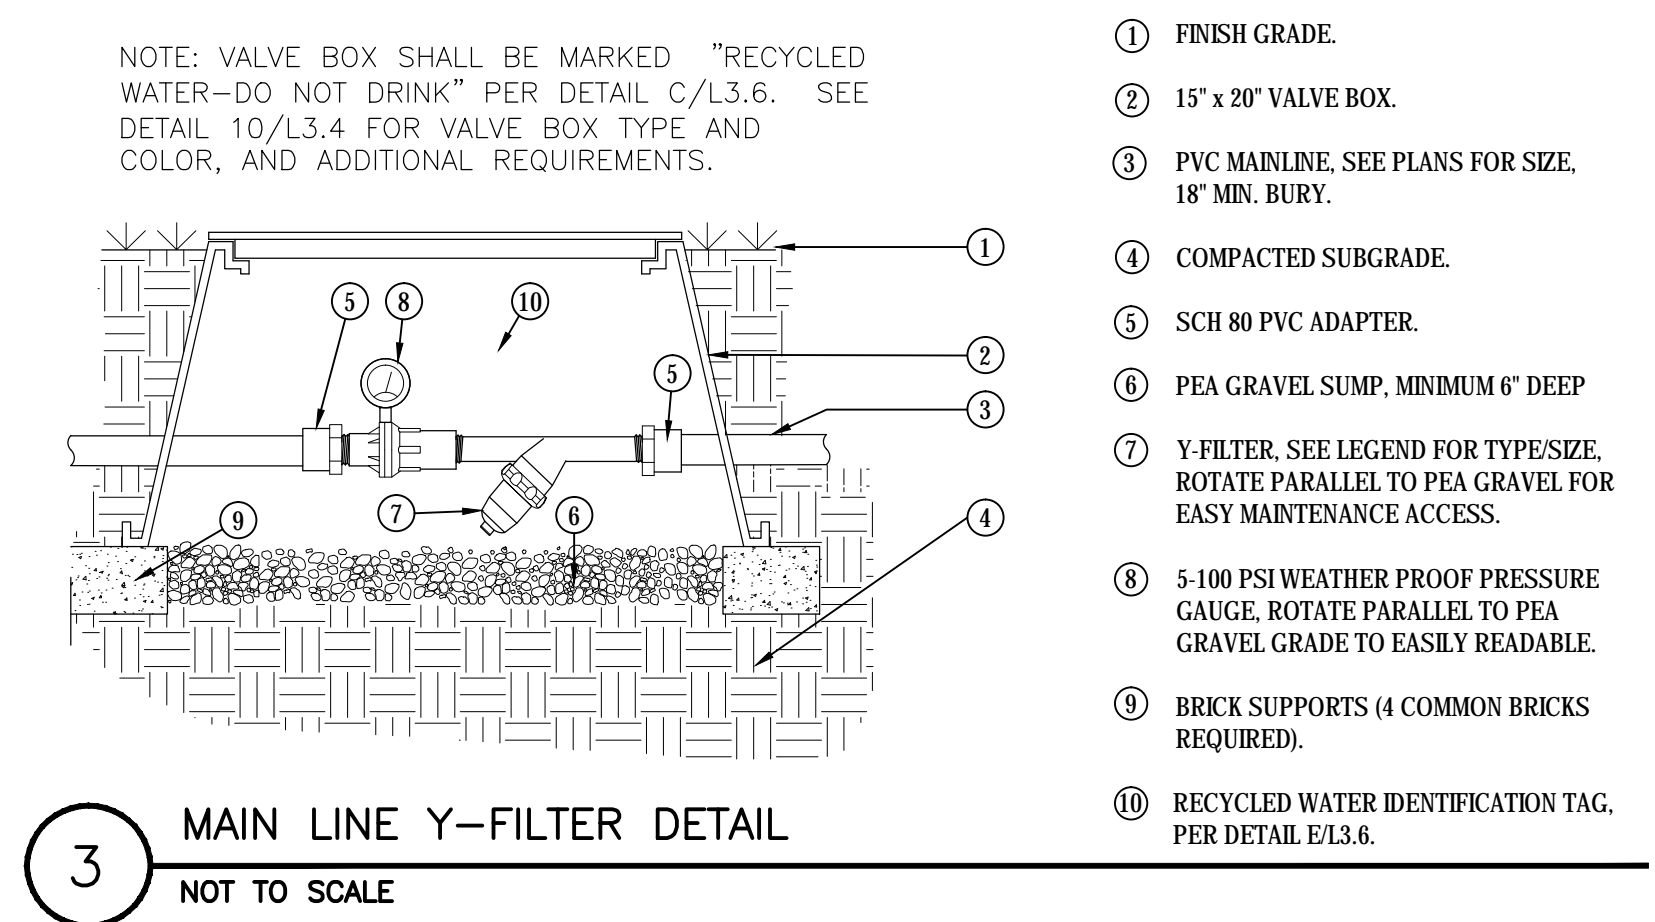


3 MAIN LINE Y-FILTER DETAIL
 NOT TO SCALE

- NOTES:
- 1 FINISH GRADE.
 - 2 15" x 20" VALVE BOX.
 - 3 PVC MAINLINE. SEE PLANS FOR SIZE, 18" MIN. BURY.
 - 4 COMPACTED SUBGRADE.
 - 5 SCH 80 PVC ADAPTER.
 - 6 PEA GRAVEL SUMP, MINIMUM 6" DEEP.
 - 7 1/2" FILTER. SEE LEGEND FOR TYPESIZE. ROTATE PARALLEL TO PEA GRAVEL FOR EASY MAINTENANCE ACCESS.
 - 8 5-100 PSI WEATHER PROOF PRESSURE GAUGE. ROTATE PARALLEL TO PEA GRAVEL GRADE TO EASILY READABLE.
 - 9 BRICK SUPPORTS (4 COMMON BRICKS REQUIRED).
 - 10 RECYCLED WATER IDENTIFICATION TAG. PER DETAIL E/L3.8.

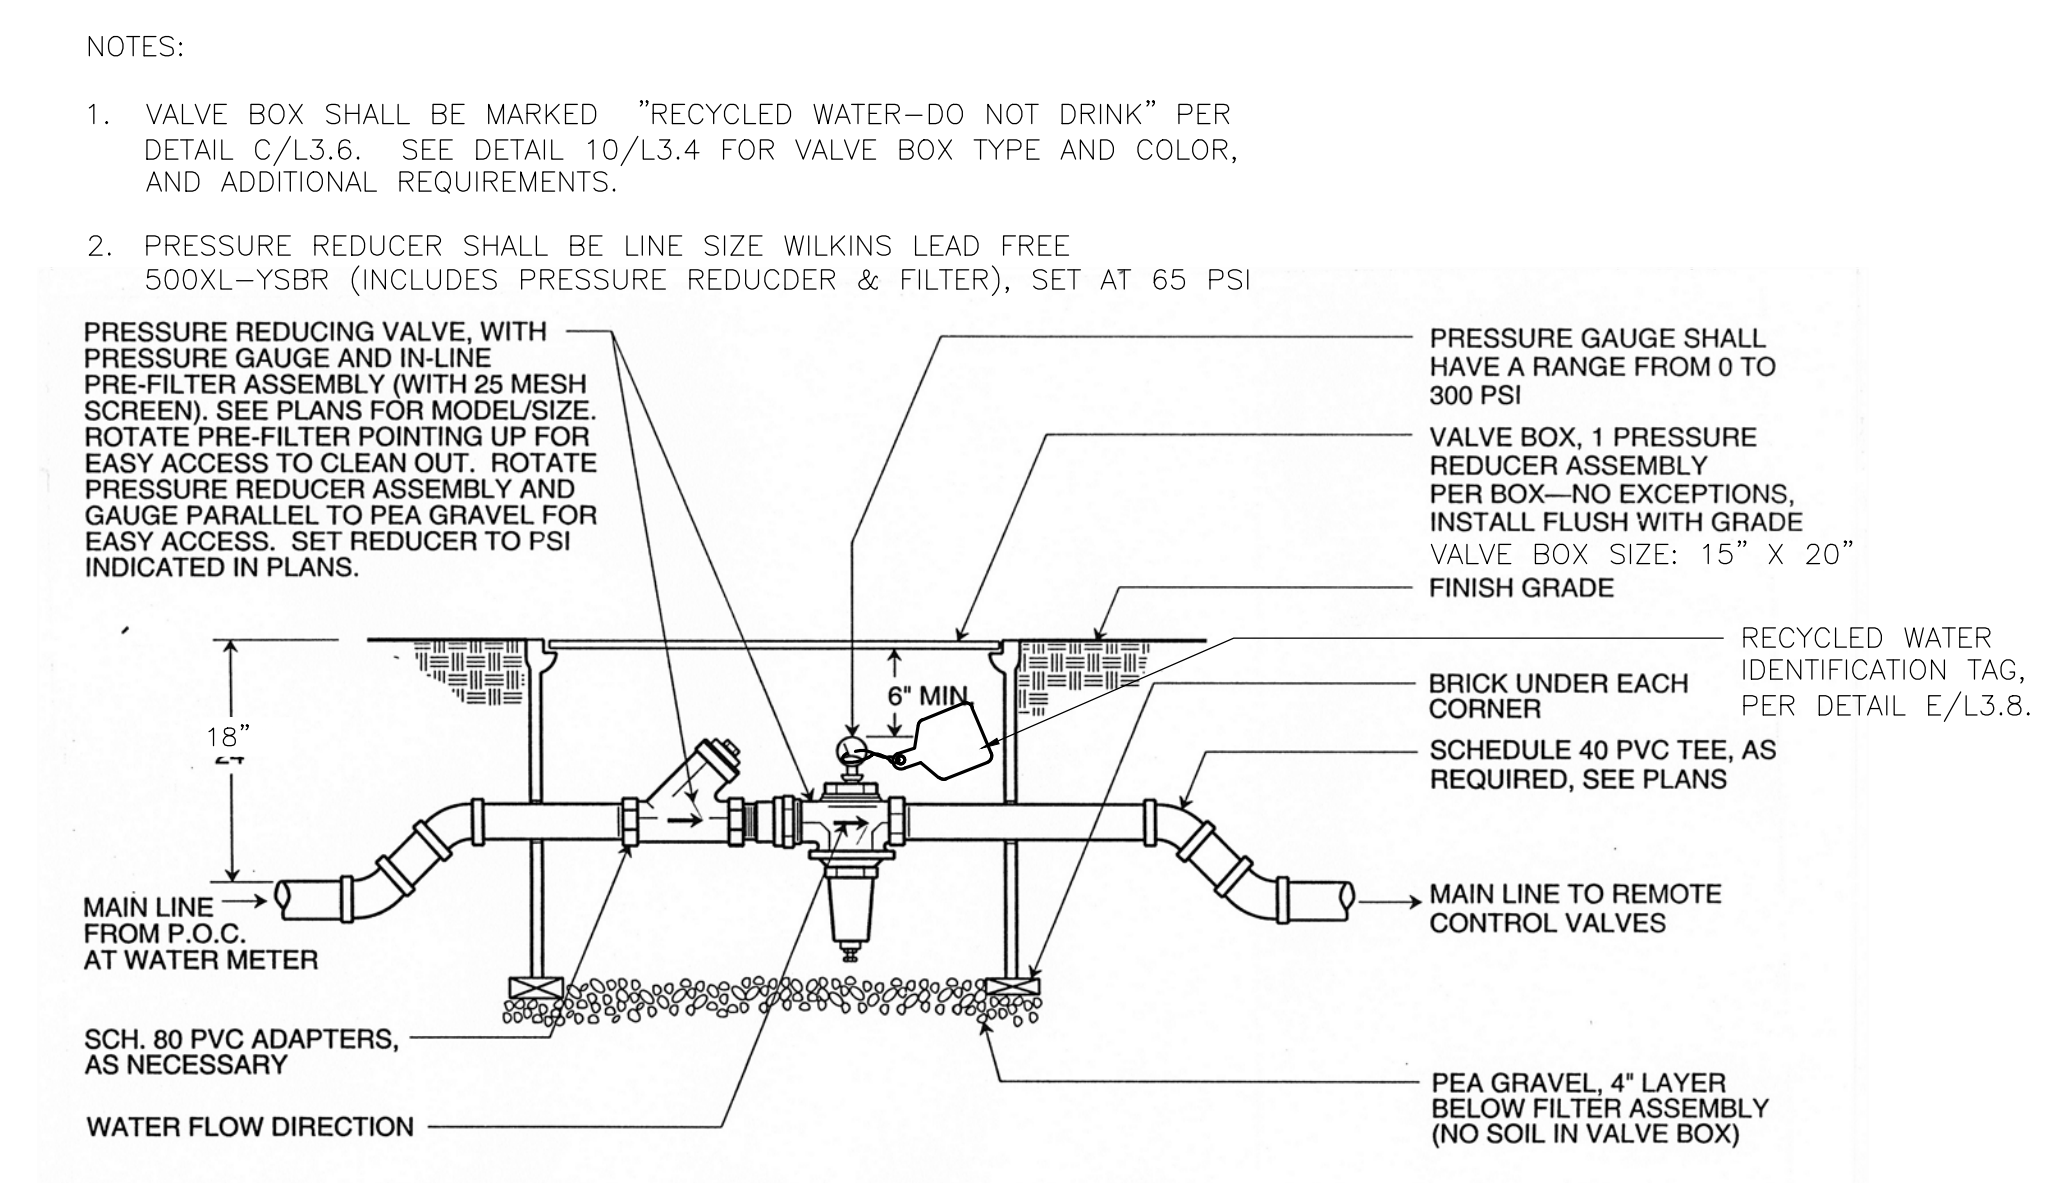

6 PRESSURE REDUCER DETAIL
 NOT TO SCALE


- NOTES:
1. VALVE BOX SHALL BE MARKED "RECYCLED WATER-DO NOT DRINK" PER DETAIL C/L3.6. SEE DETAIL 10/L3.4 FOR VALVE BOX TYPE AND COLOR, AND ADDITIONAL REQUIREMENTS.
 2. PRESSURE REDUCER SHALL BE LINE SIZE WILKINS LEAD FREE 500XL-YSBR (INCLUDES PRESSURE REDUCER & FILTER). SET AT 65 PSI
- PRESSURE REDUCING VALVE, WITH PRESSURE GAUGE AND IN-LINE PRE-FILTER ASSEMBLY (WITH 20 MESH SCREEN). SEE PLANS FOR MODEL/SIZE. ROTATE PRE-FILTER POINTING UP FOR EASY ACCESS TO CLEAN OUT. ROTATE PRESSURE REDUCER ASSEMBLY AND GAUGE PARALLEL TO PEA GRAVEL FOR EASY ACCESS. SET REDUCER TO PSI INDICATED IN PLANS.
- PRESSURE GAUGE SHALL HAVE A RANGE FROM 0 TO 300 PSI
- VALVE BOX, 1 PRESSURE REDUCER ASSEMBLY PER BOX—NO EXCEPTIONS, INSTALL FLUSH WITH GRADE
- VALVE BOX SIZE: 15" X 20" FINISH GRADE
- RECYCLED WATER IDENTIFICATION TAG, PER DETAIL E/L3.8.
- BRICK UNDER EACH CORNER
- SCHEDULE 40 PVC TEE, AS REQUIRED, SEE PLANS
- 18"
- 6" MIN.
- MAIN LINE FROM P.O.C. AT WATER METER
- MAIN LINE TO REMOTE CONTROL VALVES
- SCH. 80 PVC ADAPTERS, AS NECESSARY
- WATER FLOW DIRECTION
- PEA GRAVEL, 4" LAYER BELOW FILTER ASSEMBLY (NO SOIL IN VALVE BOX)

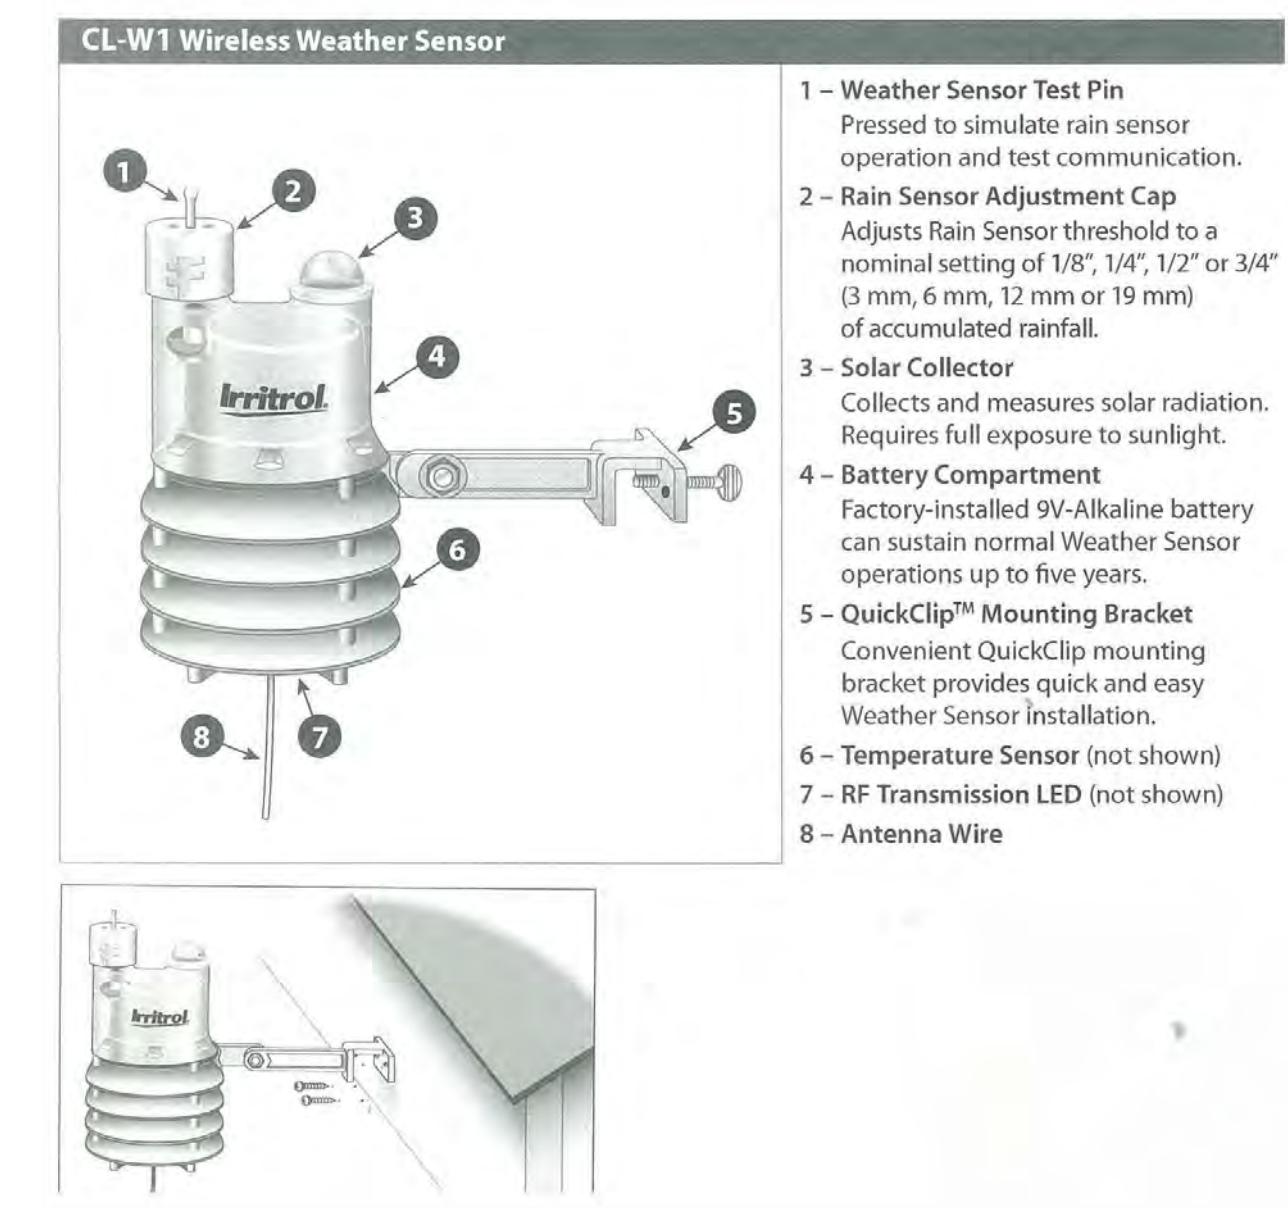

2 WEATHER SENSOR DETAIL
 NOT TO SCALE


- NOTES:
- 1 - Weather Sensor Test Pin
Pressed to simulate rain sensor operation and test communication.
 - 2 - Rain Sensor Adjustment Cap
Adjusts Rain Sensor threshold to a nominal setting of 1/8", 1/4", 1/2" or 3/4" (3 mm, 6 mm, 12 mm or 19 mm) of accumulated rainfall.
 - 3 - Solar Collector
Collects and measures solar radiation. Requires full exposure to sunlight.
 - 4 - Battery Compartment
Factory-installed 9V-Alkaline battery can sustain normal Weather Sensor operations up to five years.
 - 5 - QuickClip™ Mounting Bracket
Convenient QuickClip mounting bracket provides quick and easy Weather Sensor installation.
 - 6 - Temperature Sensor (not shown)
 - 7 - RF Transmission LED (not shown)
 - 8 - Antenna Wire

- NOTES:
1. INSTALL WEATHER SENSOR PER MANUFACTURERS SPECIFICATIONS.
 2. INSTALL AT LOCATION NOTED ON IRRIGATION PLANS, IN AREA WITH FULL SUN EXPOSURE, IN LOCATION APPROVED BY OWNER'S REPRESENTATIVE.
 3. DO NOT LOCATE SENSOR WHERE THERE IS SHADE, OR UNDER TREES, OR UNDER EAVE OF BLDG.

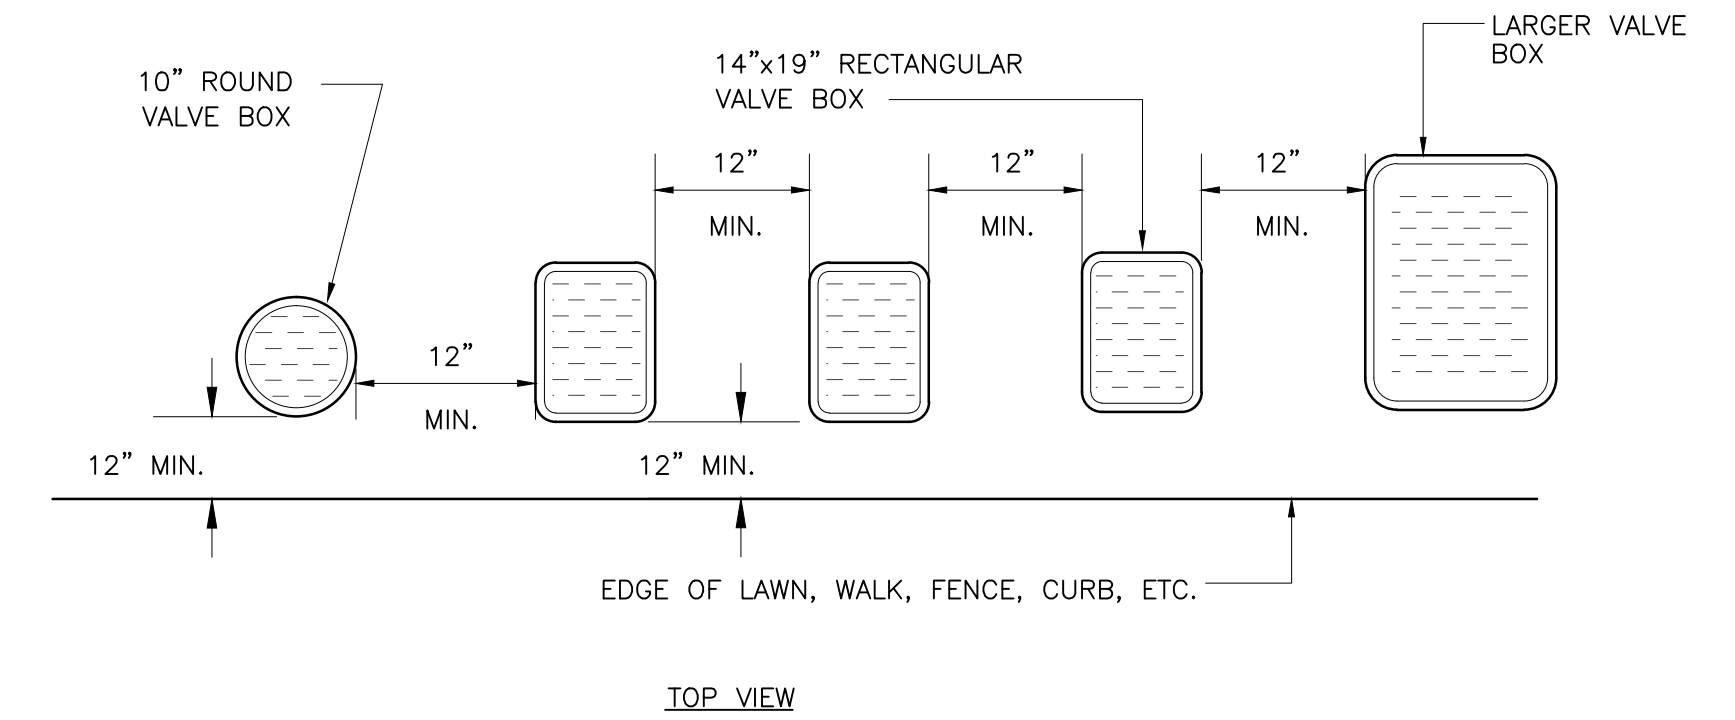


- NOTES:
1. CENTER BOX OVER VALVE TO FACILITATE SERVICING VALVE.
 3. SET BOXES 1" ABOVE FINISH GRADE OR MULCH COVER IN GROUND COVER/SHRUB AREA AND FLUSH WITH FINISH GRADE IN TURF AREA.
 4. SET VALVE BOX ASSEMBLY IN GROUND COVER/SHRUB AREA WHERE POSSIBLE. INSTALL IN LAWN AREA ONLY IF GROUND COVER/SHRUB AREA DOES NOT EXIST ADJACENT TO LAWN.
 5. SET BOXES PARALLEL TO EACH OTHER AND PERPENDICULAR TO EDGE.
 6. AVOID HEAVILY COMPACTING SOIL AROUND VALVE BOX EDGES TO PREVENT COLLAPSE AND DEFORMATION OF VALVE BOX SIDES.
 7. VALVE BOXES COLOR SHALL BE PURPLE. VALVE BOXES SHALL HAVE BOLT DOWN LIDS WITH BOLTS INSTALLED.
 8. VALVE BOXES SHALL BE BY CARSON, OR EQUIVALENT.
 9. VALVE BOX SHALL BE MARKED "RECYCLED WATER - DO NOT DRINK", PER DETAIL C/L3.6.

5 VALVE BOX LAYOUT DETAIL
 NOT TO SCALE

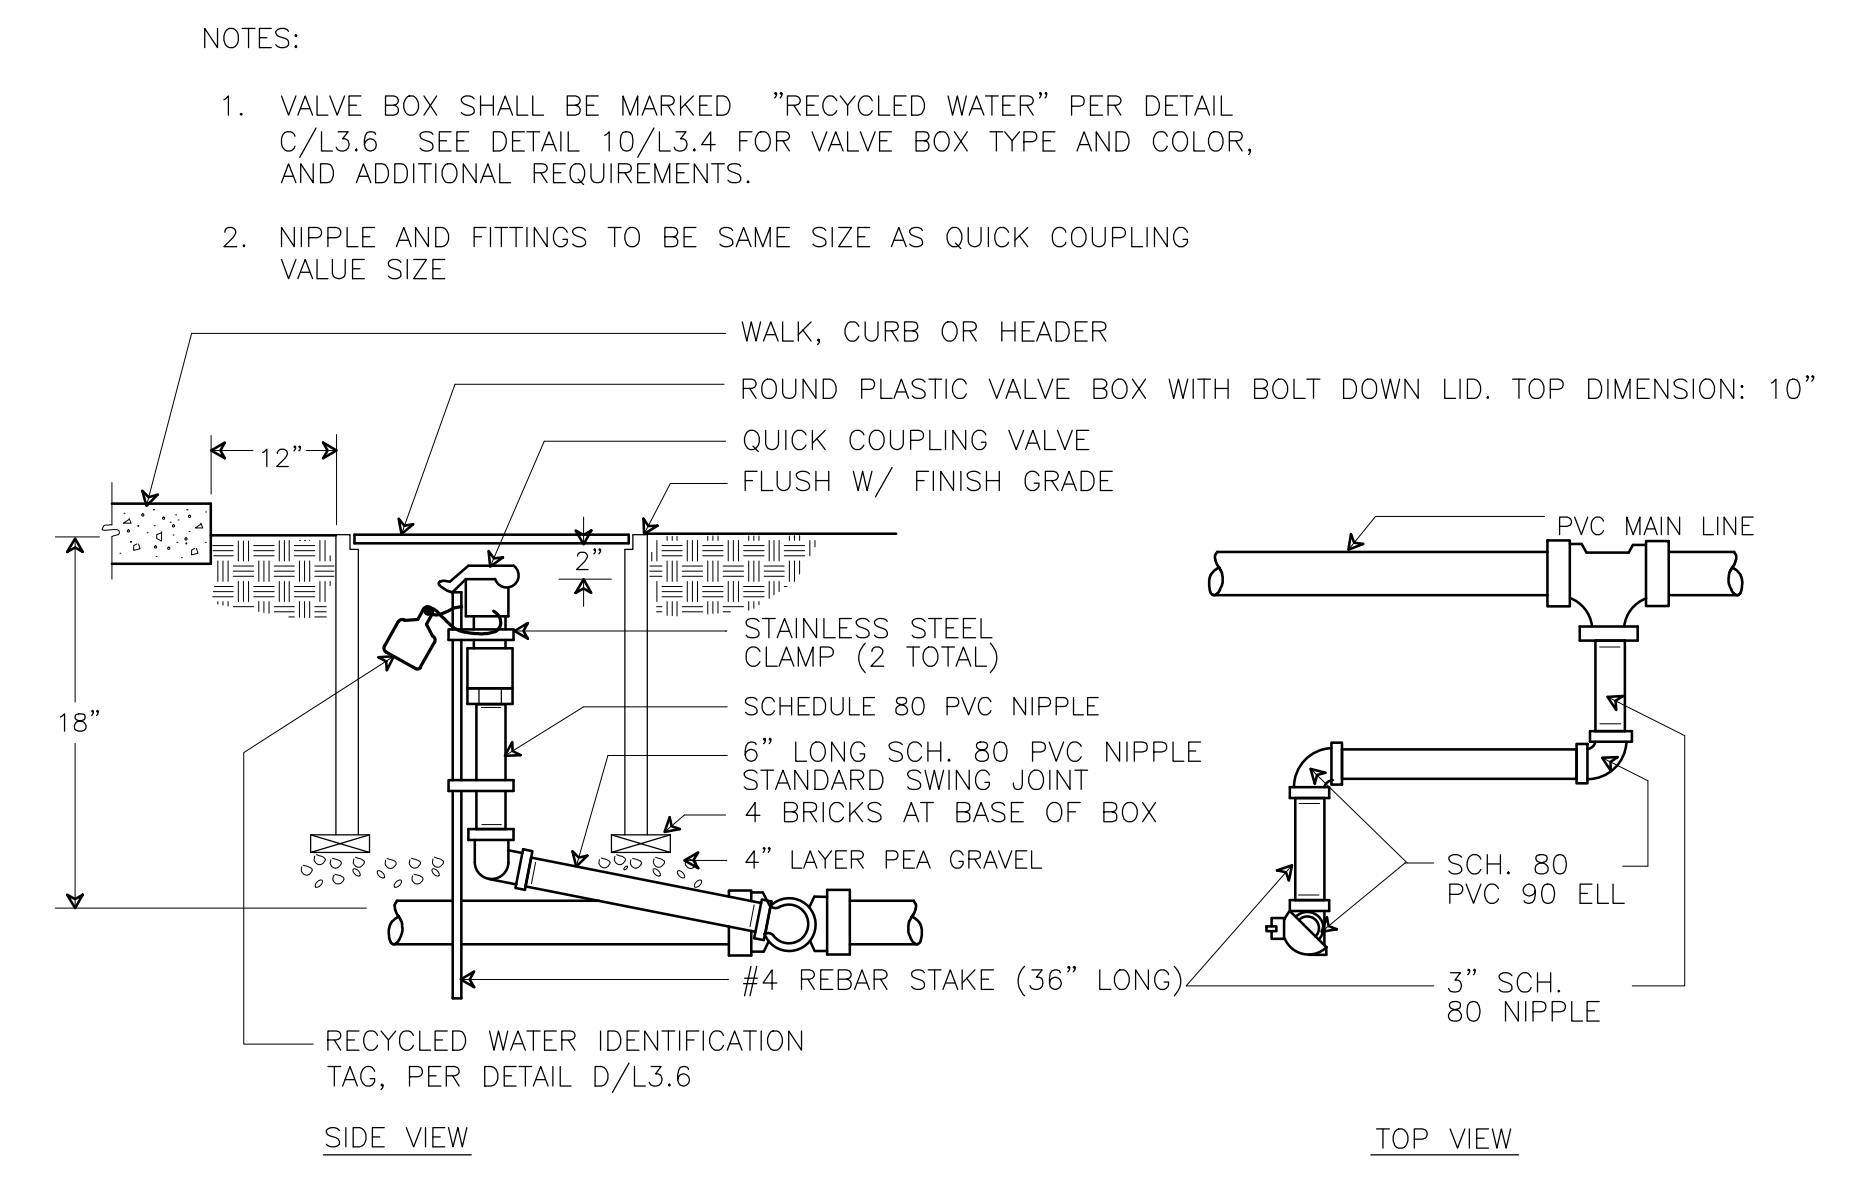


1 QUICK COUPLER VALVE DETAIL
 NOT TO SCALE

- NOTES:
1. VALVE BOX SHALL BE MARKED "RECYCLED WATER" PER DETAIL C/L3.6. SEE DETAIL 10/L3.4 FOR VALVE BOX TYPE AND COLOR, AND ADDITIONAL REQUIREMENTS.
 2. NIPPLE AND FITTINGS TO BE SAME SIZE AS QUICK COUPLING VALVE SIZE
- WALK, CURB OR HEADER
- ROUND PLASTIC VALVE BOX WITH BOLT DOWN LID. TOP DIMENSION: 10"
- QUICK COUPLING VALVE
- FLUSH W/ FINISH GRADE
- 12"
- 18"
- PVC MAIN LINE
- STAINLESS STEEL CLAMP (2 TOTAL)
- SCHEDULE 80 PVC NIPPLE
- 6" LONG SCH. 80 PVC NIPPLE STANDARD SWING JOINT
- 4 BRICKS AT BASE OF BOX
- 4" LAYER PEA GRAVEL
- #4 REBAR STAKE (36" LONG)
- 3" SCH. 80 PVC 90 ELL
- 3" SCH. 80 NIPPLE
- RECYCLED WATER IDENTIFICATION TAG, PER DETAIL D/L3.6
- SIDE VIEW
- TOP VIEW

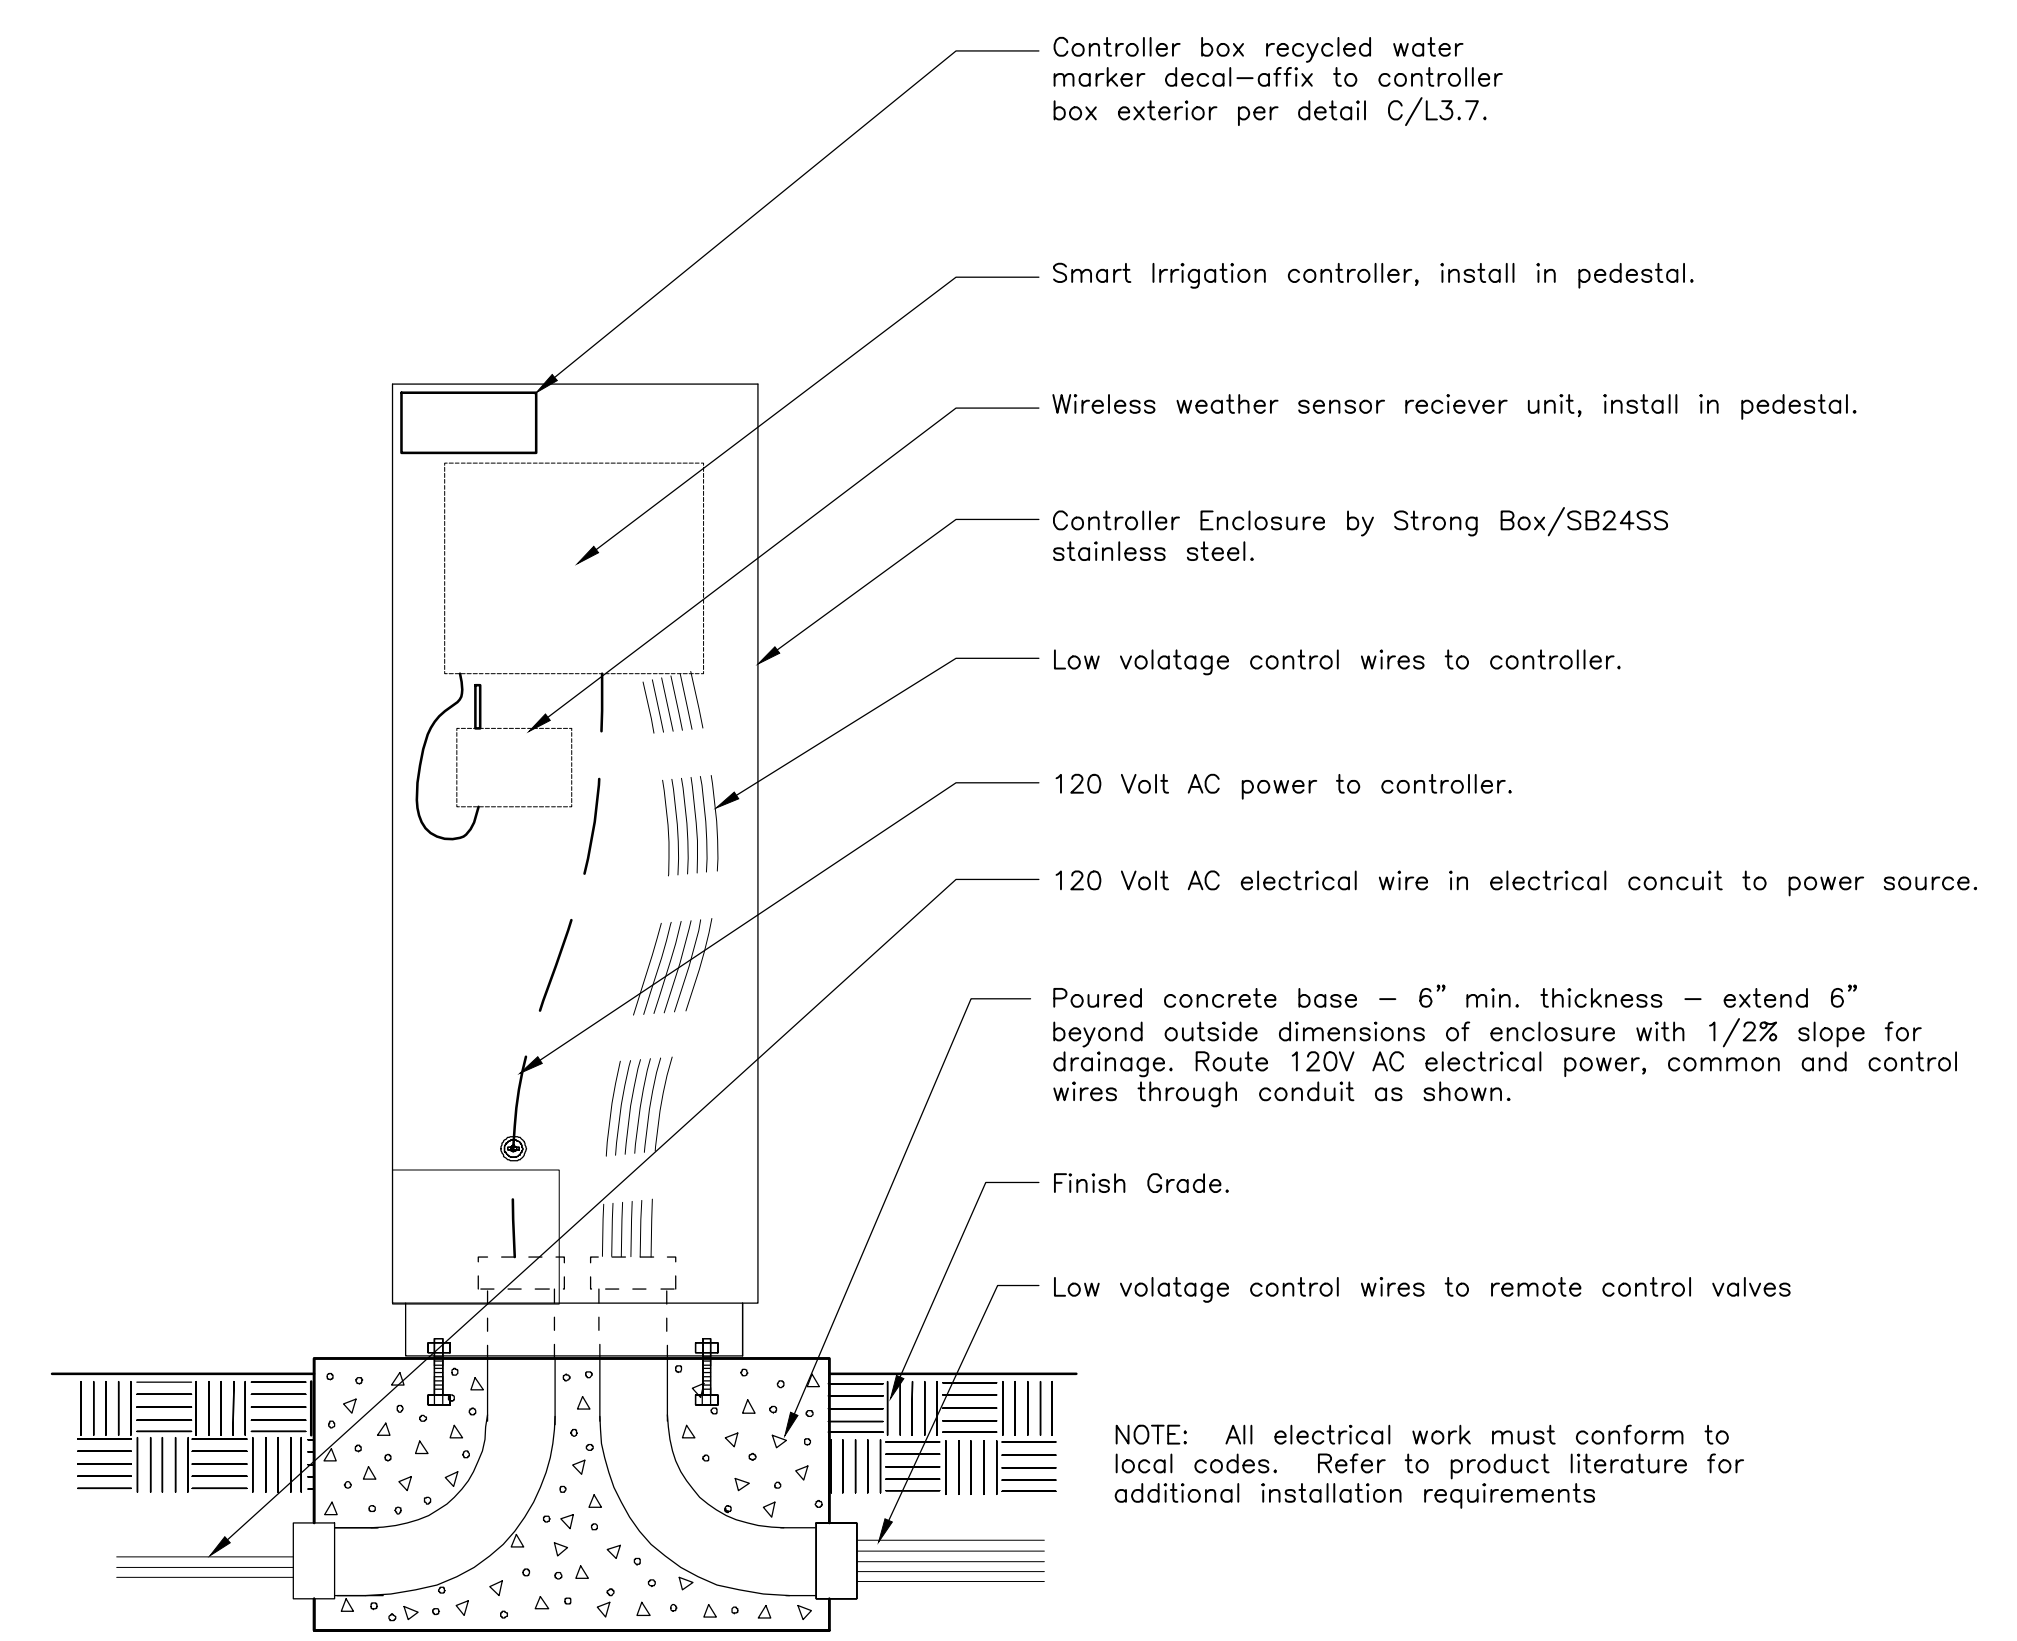

4 PEDESTAL MOUNT IRRIGATION CONTROLLER "A" DETAIL
 NOT TO SCALE


- Controller box recycled water marker decal—affix to controller box exterior per detail C/L3.7.
- Smart Irrigation controller, install in pedestal.
- Wireless weather sensor receiver unit, install in pedestal.
- Controller Enclosure by Strong Box/SB24SS stainless steel.
- Low voltage control wires to controller.
- 120 Volt AC power to controller.
- 120 Volt AC electrical wire in electrical conduit to power source.
- Poured concrete base - 6" min. thickness - extend 6" beyond outside dimensions of enclosure with 1/2% slope for drainage. Route 120V AC electrical power, common and control wires through conduit as shown.
- Finish Grade.
- Low voltage control wires to remote control valves
- NOTE: All electrical work must conform to local codes. Refer to product literature for additional installation requirements

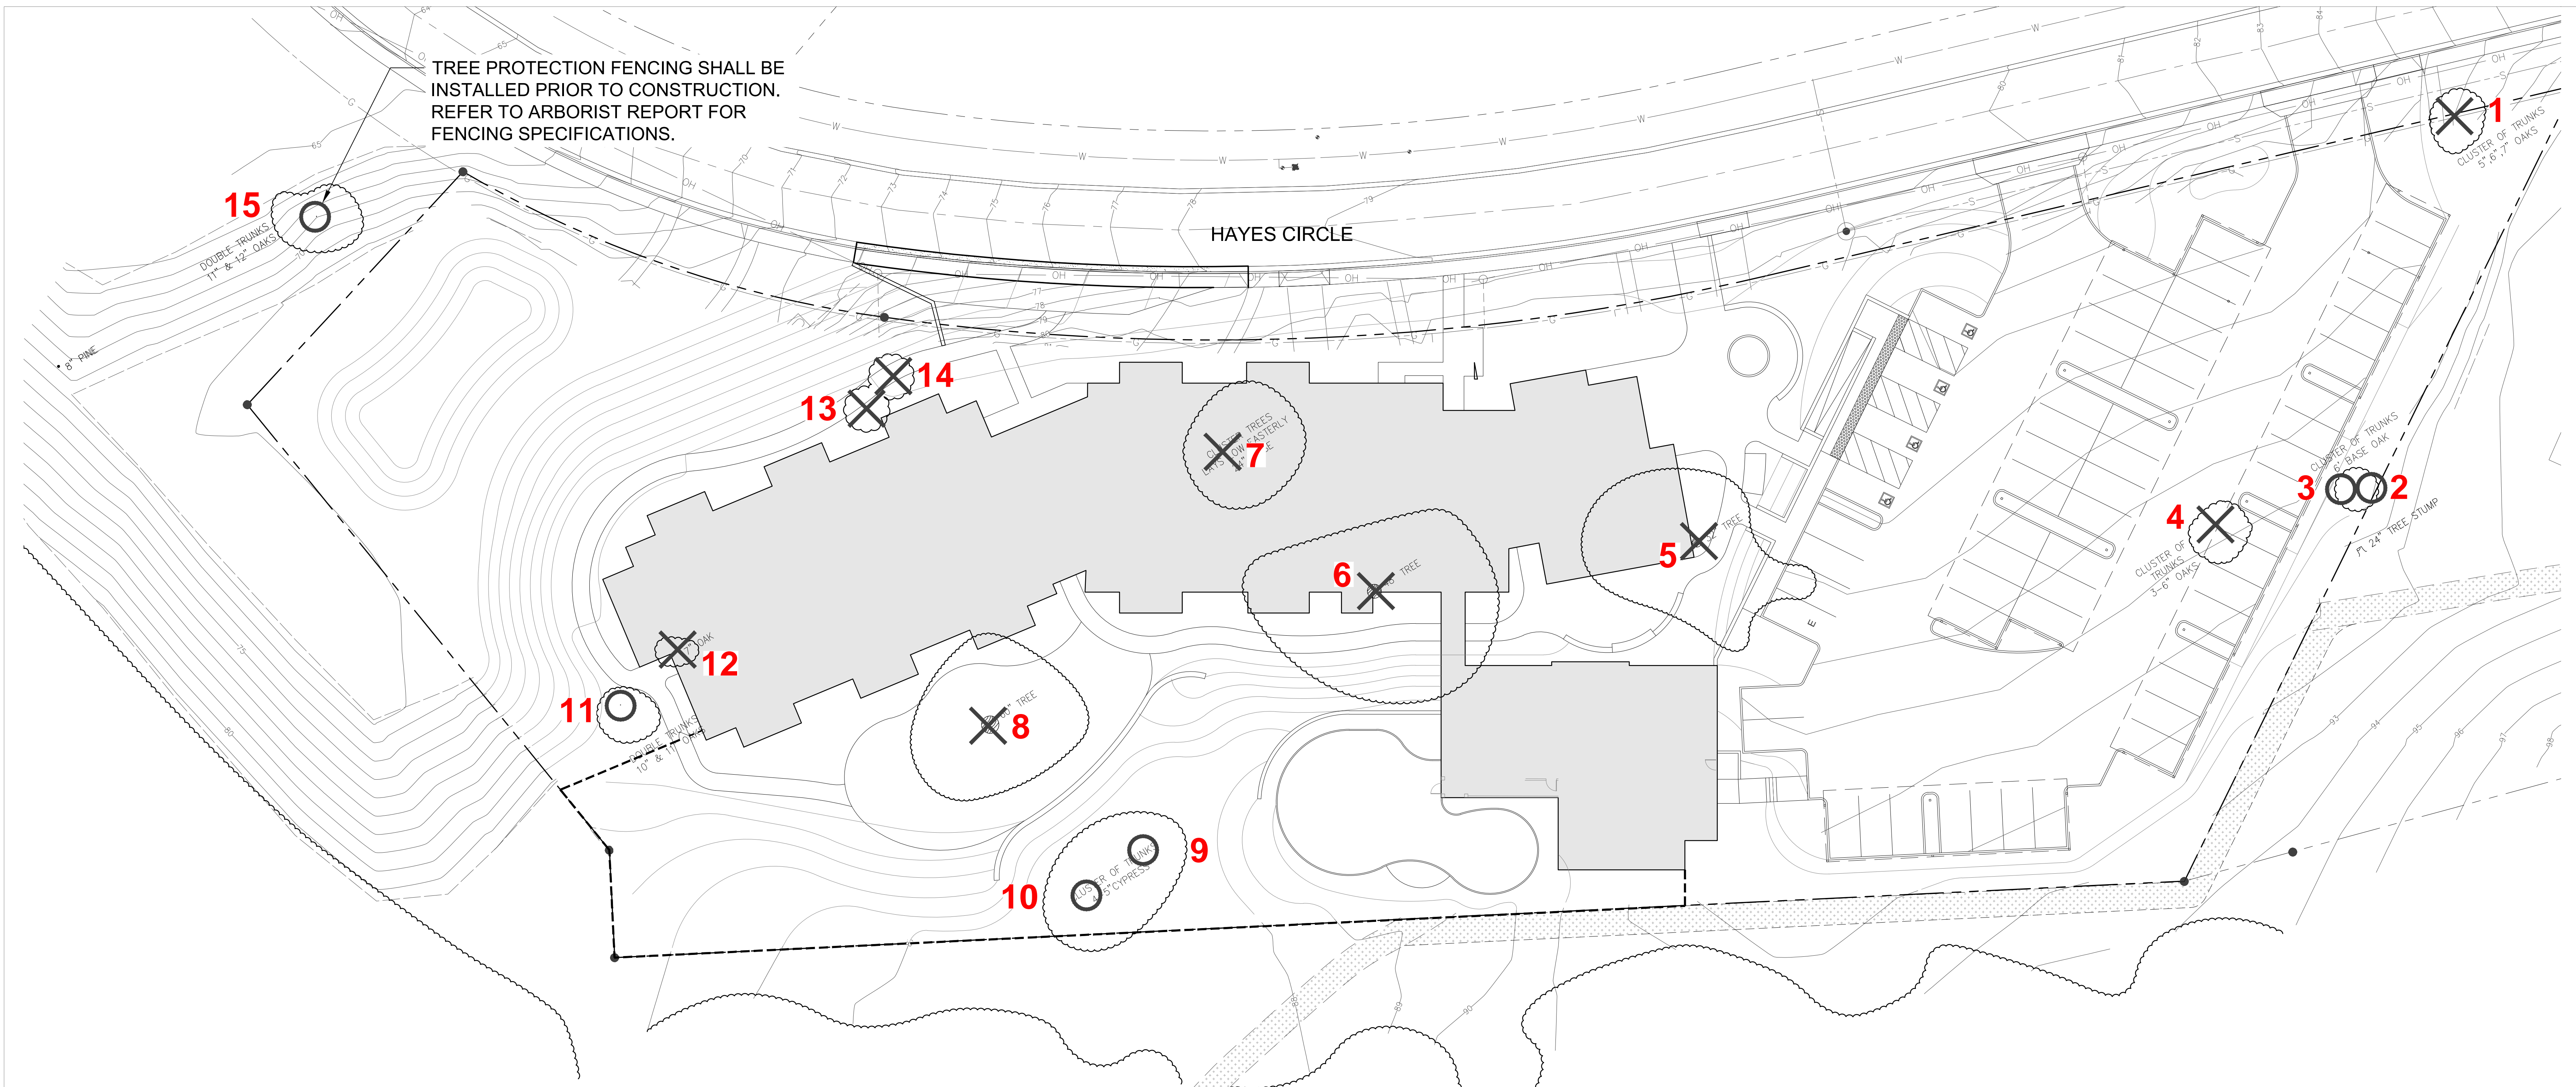


TREE INVENTORY TABLE

TREE#	SPECIES	TRUNK DIAMETER AT 4.5'	HEALTH RATING	COMMENTS/ OBSERVATIONS	SUITABILITY FOR PRESERVATION (BASED UPON CONDITION)	CONSTRUCTION IMPACT
1	BLACKWOOD ACACIA (ACACIA MELANOXYLON)	4";5.75";6"	1.5	Small tree with three trunks forming at grade. One trunk is prostrate. This tree is in decline with very low vigor and extensive branch and twig dieback.	POOR	REMOVE
2	COAST LIVE OAK (QUERCUS AGRIFOLIA)	3"; 6.5"±	3.0	Part of a two tree cluster. Low, dense structure with asymmetrical crown extending to east. No significant structural defects. Vigor and foliage density are moderate.	GOOD	REMAIN
3	COAST LIVE OAK (QUERCUS AGRIFOLIA)	2"-5"	3.0	Low, multi-trunk tree growing next to tree #2. Trunks form at grade with deep leaf litter covering base. Possibly more than one tree. No significant structural defects. Vigor and foliage density are moderate. Dead, collapsed Monterey pine is leaning on portion of tree.	GOOD	REMAIN
4	COAST LIVE OAK (QUERCUS AGRIFOLIA)	2"-5"	2.0	Dense, multiple trunk trees with trunks forming at grade. Trunk attachments are included at base. Vigor and foliage density are variable with significant branch and twig dieback occurring.	MODERATE	REMOVE
5	MONTEREY CYPRESS (HESPEROCYPARIS MACROCARPA)	30.5"	2.5	Mature tree with closely spaced, multiple limb attachments forming at 10'. Contortion in trunk at 10'. Tree has history of pruning with heading cuts locations evident. Tree has history of limb failure. Upper crown has large diameter and extended limbs. Lower trunk appears sound with good radial root distribution. Vigor and foliage density is variable with significant limb and branch dieback occurring in lower crown. Probable Seridium canker infections occurring and boring beetle damage.	MODERATE	REMOVE
6	MONTEREY CYPRESS (HESPEROCYPARIS MACROCARPA)	26.5"; 28.0"	2.5	Mature tree with co-dominant trunks forming at 3'. Wide trunk attachment angle. 28" trunk has closely spaced, multiple limb attachments forming at 6'-7" with upright form. 26.5" trunk has three trunks forming at 6'-7" with generally acceptable attachments. The primary trunk is vertical with extended, horizontal limbs. Lower trunk appears sound with good radial root distribution. Vigor and foliage density is variable with significant limb and branch dieback occurring in lower crown on east side.	MODERATE	REMOVE
7	BUSHY YATE (EUCALYPTUS LEHMANII)	10";11";13"	3.0	Low, multiple trunk structure with strong asymmetrical crown extending to east. In addition to the three primary stems there are numerous 3"-4" stems at base of trunk. Tree may have partially collapsed in past, but is now stable. Vigor and foliage density are moderate with limited branch dieback occurring.	MODERATE	REMOVE
8	MONTEREY CYPRESS (HESPEROCYPARIS MACROCARPA)	7";8"8"9" 10";11";12"; 12";14";15"	3.0	Multiple trunk structure forming at 3' with limited included attachment. Symmetrical crown form and very dense branch and limb structure. Mostly vertical trunks. One trunk on south side is angled and then ascending. Probably the result of an old limb failure. One large diameter surface root extends to the walkway. Root system is likely extensive. Vigor and foliage density is moderate.	MODERATE	REMOVE
9	MONTEREY CYPRESS (HESPEROCYPARIS MACROCARPA)	3"-6"	3.0	Low, dense multiple trunk structure forming at grade. Low, open structure. Sap exudate widely present on trunks, although generally moderate vigor and foliage density.	MODERATE	REMAIN
10	MONTEREY CYPRESS (HESPEROCYPARIS MACROCARPA)	2"-3"	3.0	Low, dense multiple trunk structure forming at grade. Low, open structure. Sap exudate widely present on trunks, although generally moderate vigor and foliage density.	MODERATE	REMAIN
11	COAST LIVE OAK (QUERCUS AGRIFOLIA)	11"; 13" (LOW)	3.0	Low, co-dominant trunk structure and then multiple trunks at 3'-5'. Trunks probably originated as basal sprouts. Symmetrical and dense crown form. Vigor is moderate.	GOOD	REMAIN
12	COAST LIVE OAK (QUERCUS AGRIFOLIA)	6.5" (LOW)	1.5	Low, single trunk structure with symmetrical form. Very low vigor and foliage density with significant branch and twig dieback occurring. Possible Diplodia infection.	POOR	REMOVE
13	MYOPORUM (MYOPORUM LAETUM)	1"-3"	1.0	Tree is mostly dead with severe dieback occurring. Myoporum thrip foliage damage.	POOR	REMOVE
14	MYOPORUM (MYOPORUM LAETUM)	1"-4"	1.0	Tree is mostly dead with severe dieback occurring. Myoporum thrip foliage damage.	POOR	REMOVE
15	COAST LIVE OAK (QUERCUS AGRIFOLIA)	6.5"; 8"; 10.5"	3.0	Low, multiple trunk structure with symmetrical crown form. Wide trunk attachments. No significant structural defects. Vigor and foliage density are moderate.	GOOD	OFFSITE

EXISTING TREES TO BE REMOVED	9
NEW PROPOSED TREES	91

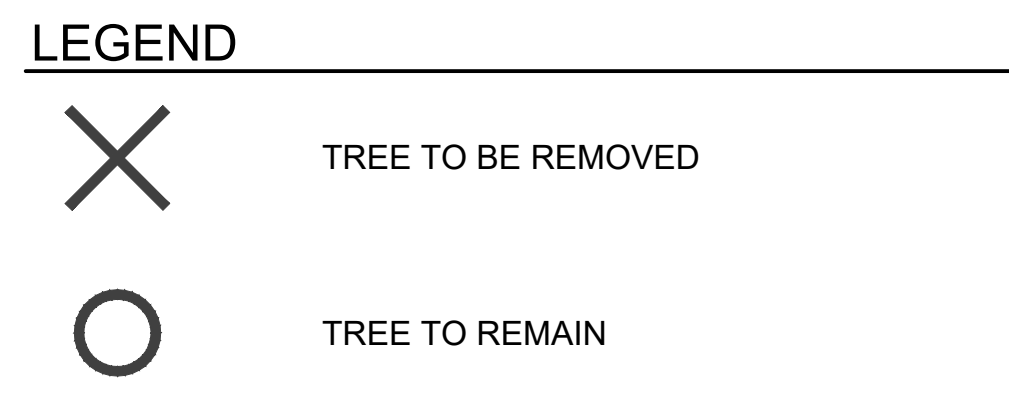

- NOTES:**
- HEALTH WAS DETERMINED BY MACNAIR AND ASSOCIATES, CONSULTING ARBORISTS AND HORTICULTURALISTS.
 - REFER TO ARBORIST REPORT, PREPARED BY MACNAIR AND ASSOCIATES, DATED 12/13/15, FOR ADDITIONAL INFORMATION.

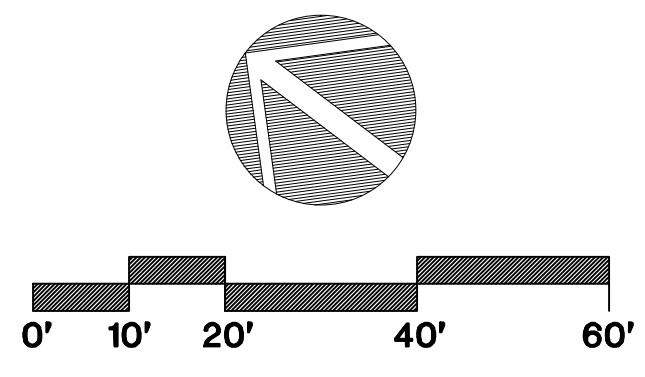

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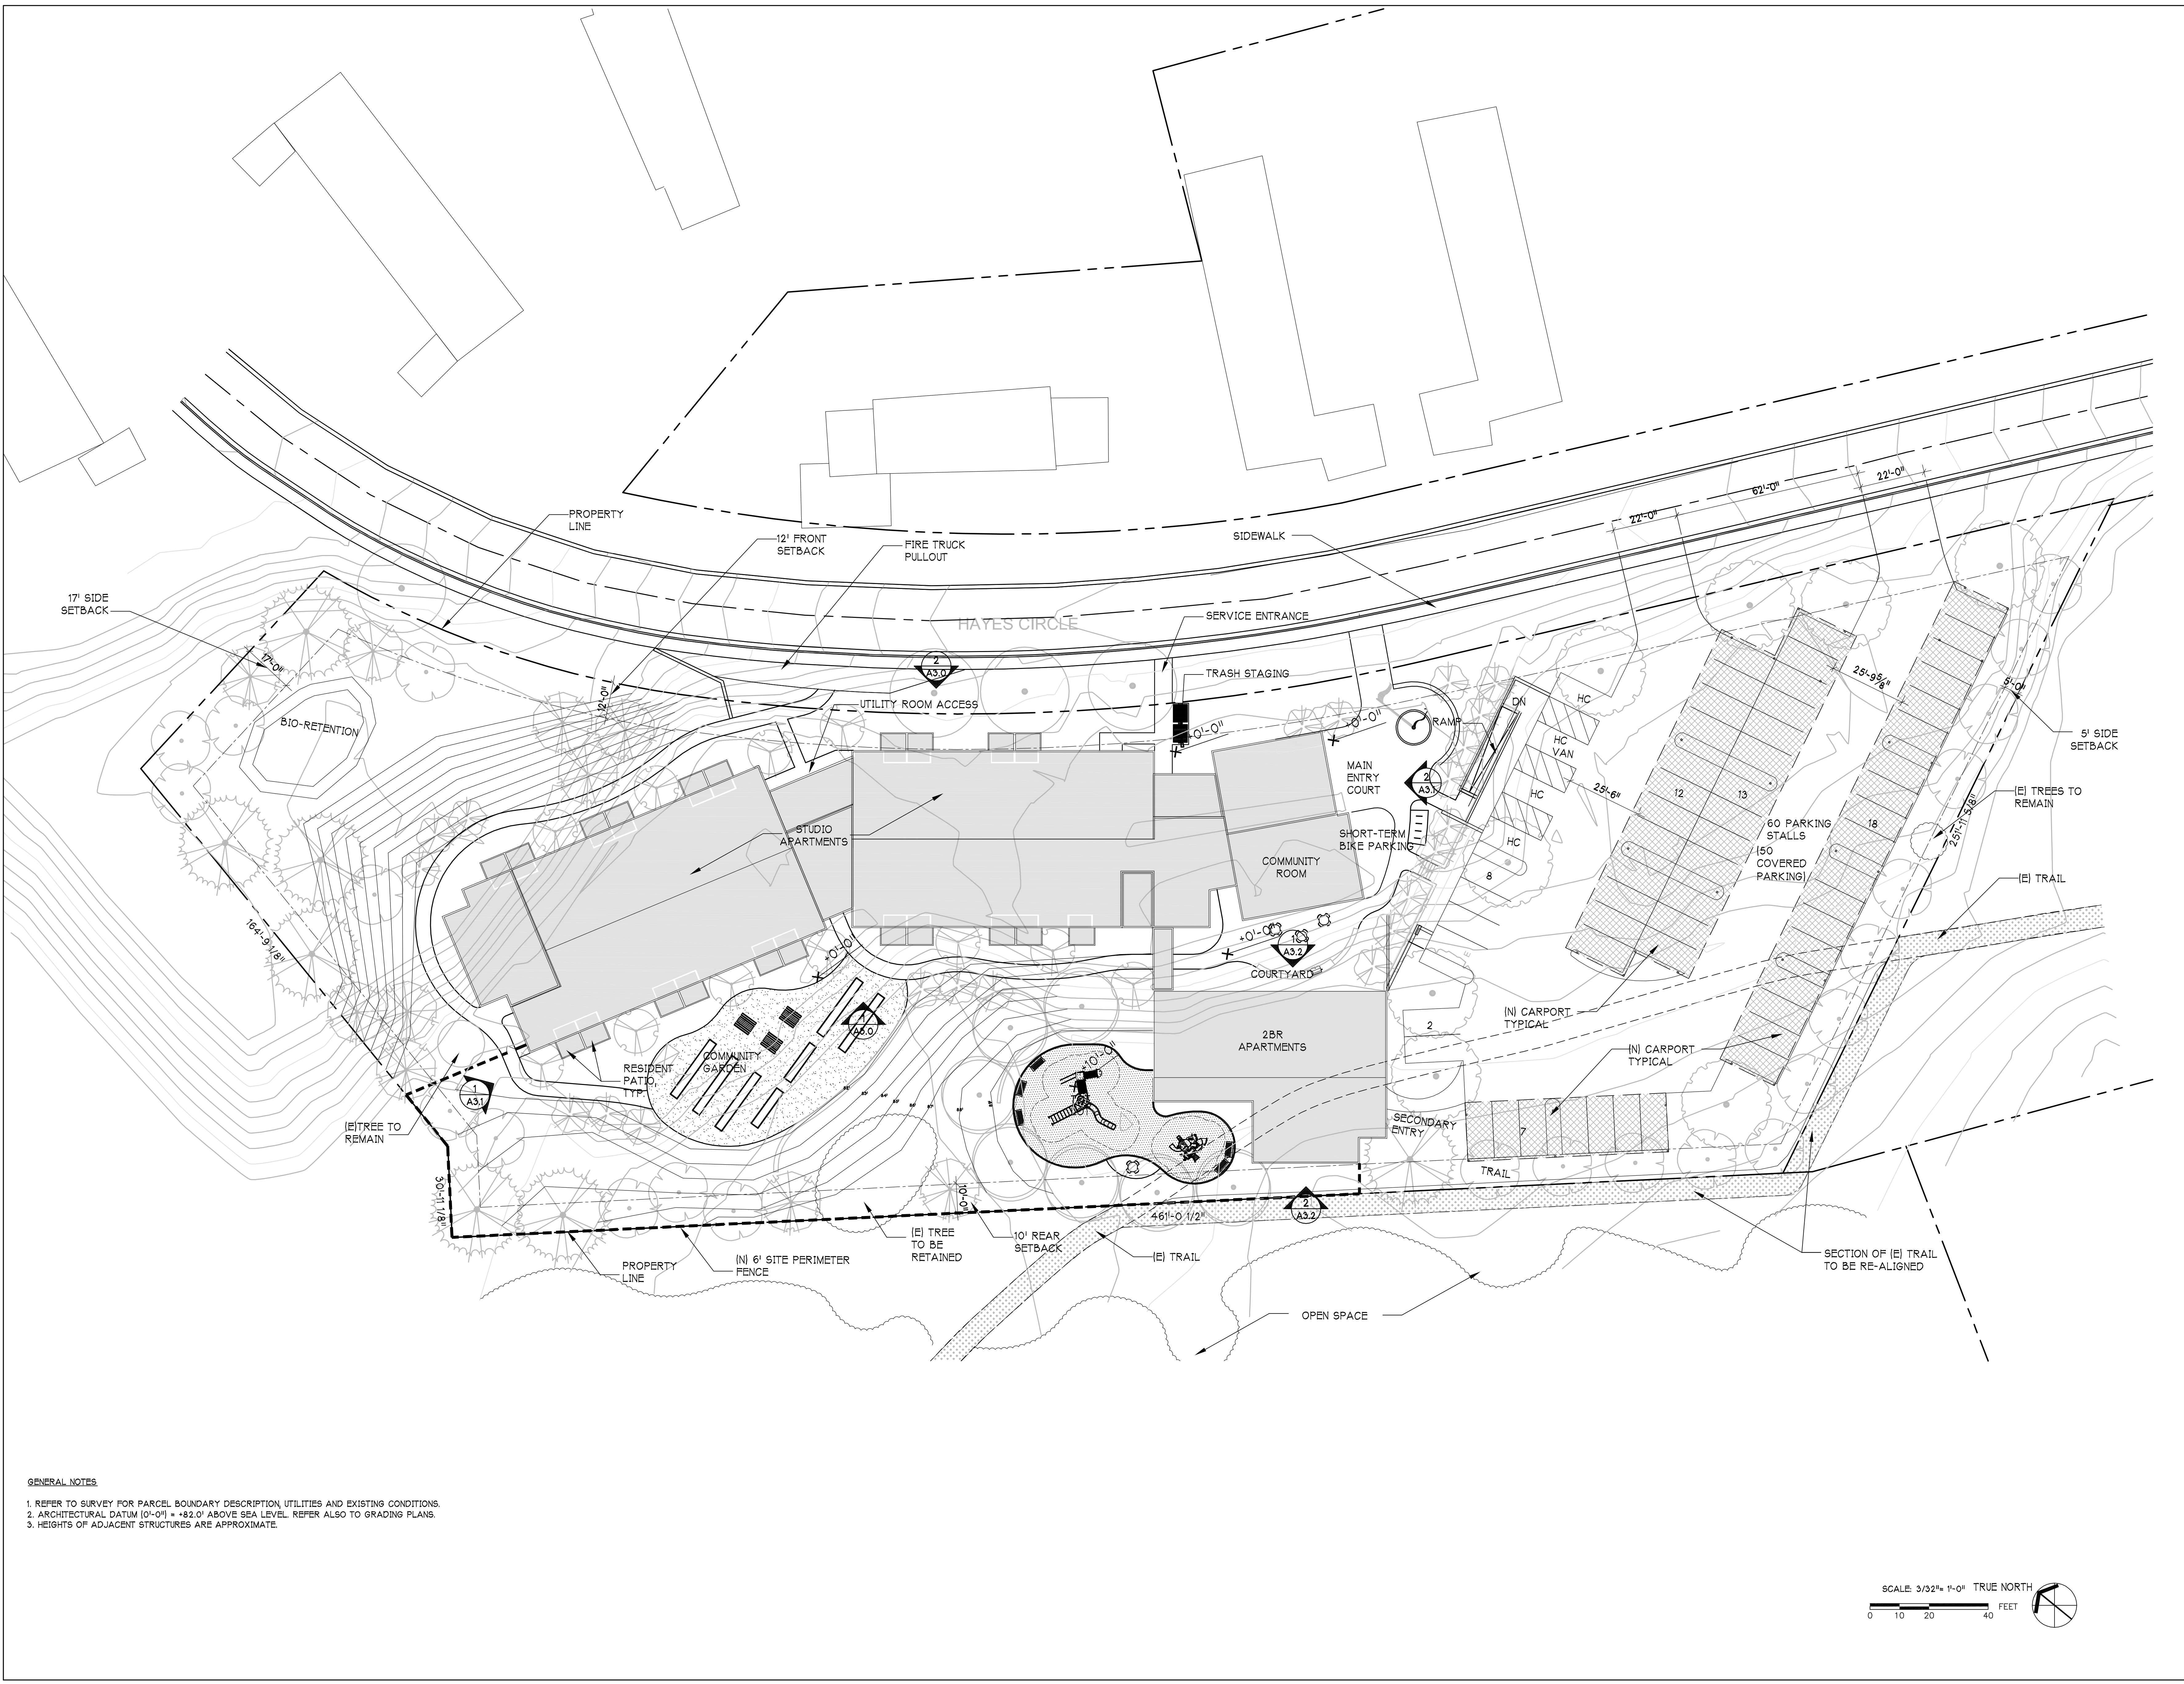
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 DR RESUBMITTAL
 2/10/2016
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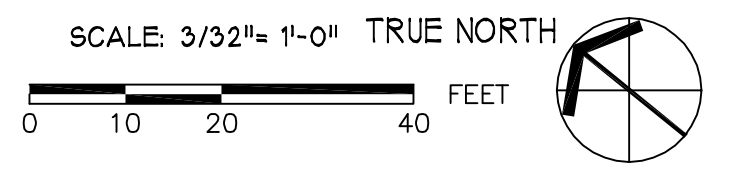
TREE PRESERVATION AND REMOVAL PLAN

SCALE 1"=20'-0"

L4.1



GENERAL NOTES
 1. REFER TO SURVEY FOR PARCEL BOUNDARY DESCRIPTION, UTILITIES AND EXISTING CONDITIONS.
 2. ARCHITECTURAL DATUM (0'-0") = +82.0' ABOVE SEA LEVEL. REFER ALSO TO GRADING PLANS.
 3. HEIGHTS OF ADJACENT STRUCTURES ARE APPROXIMATE.



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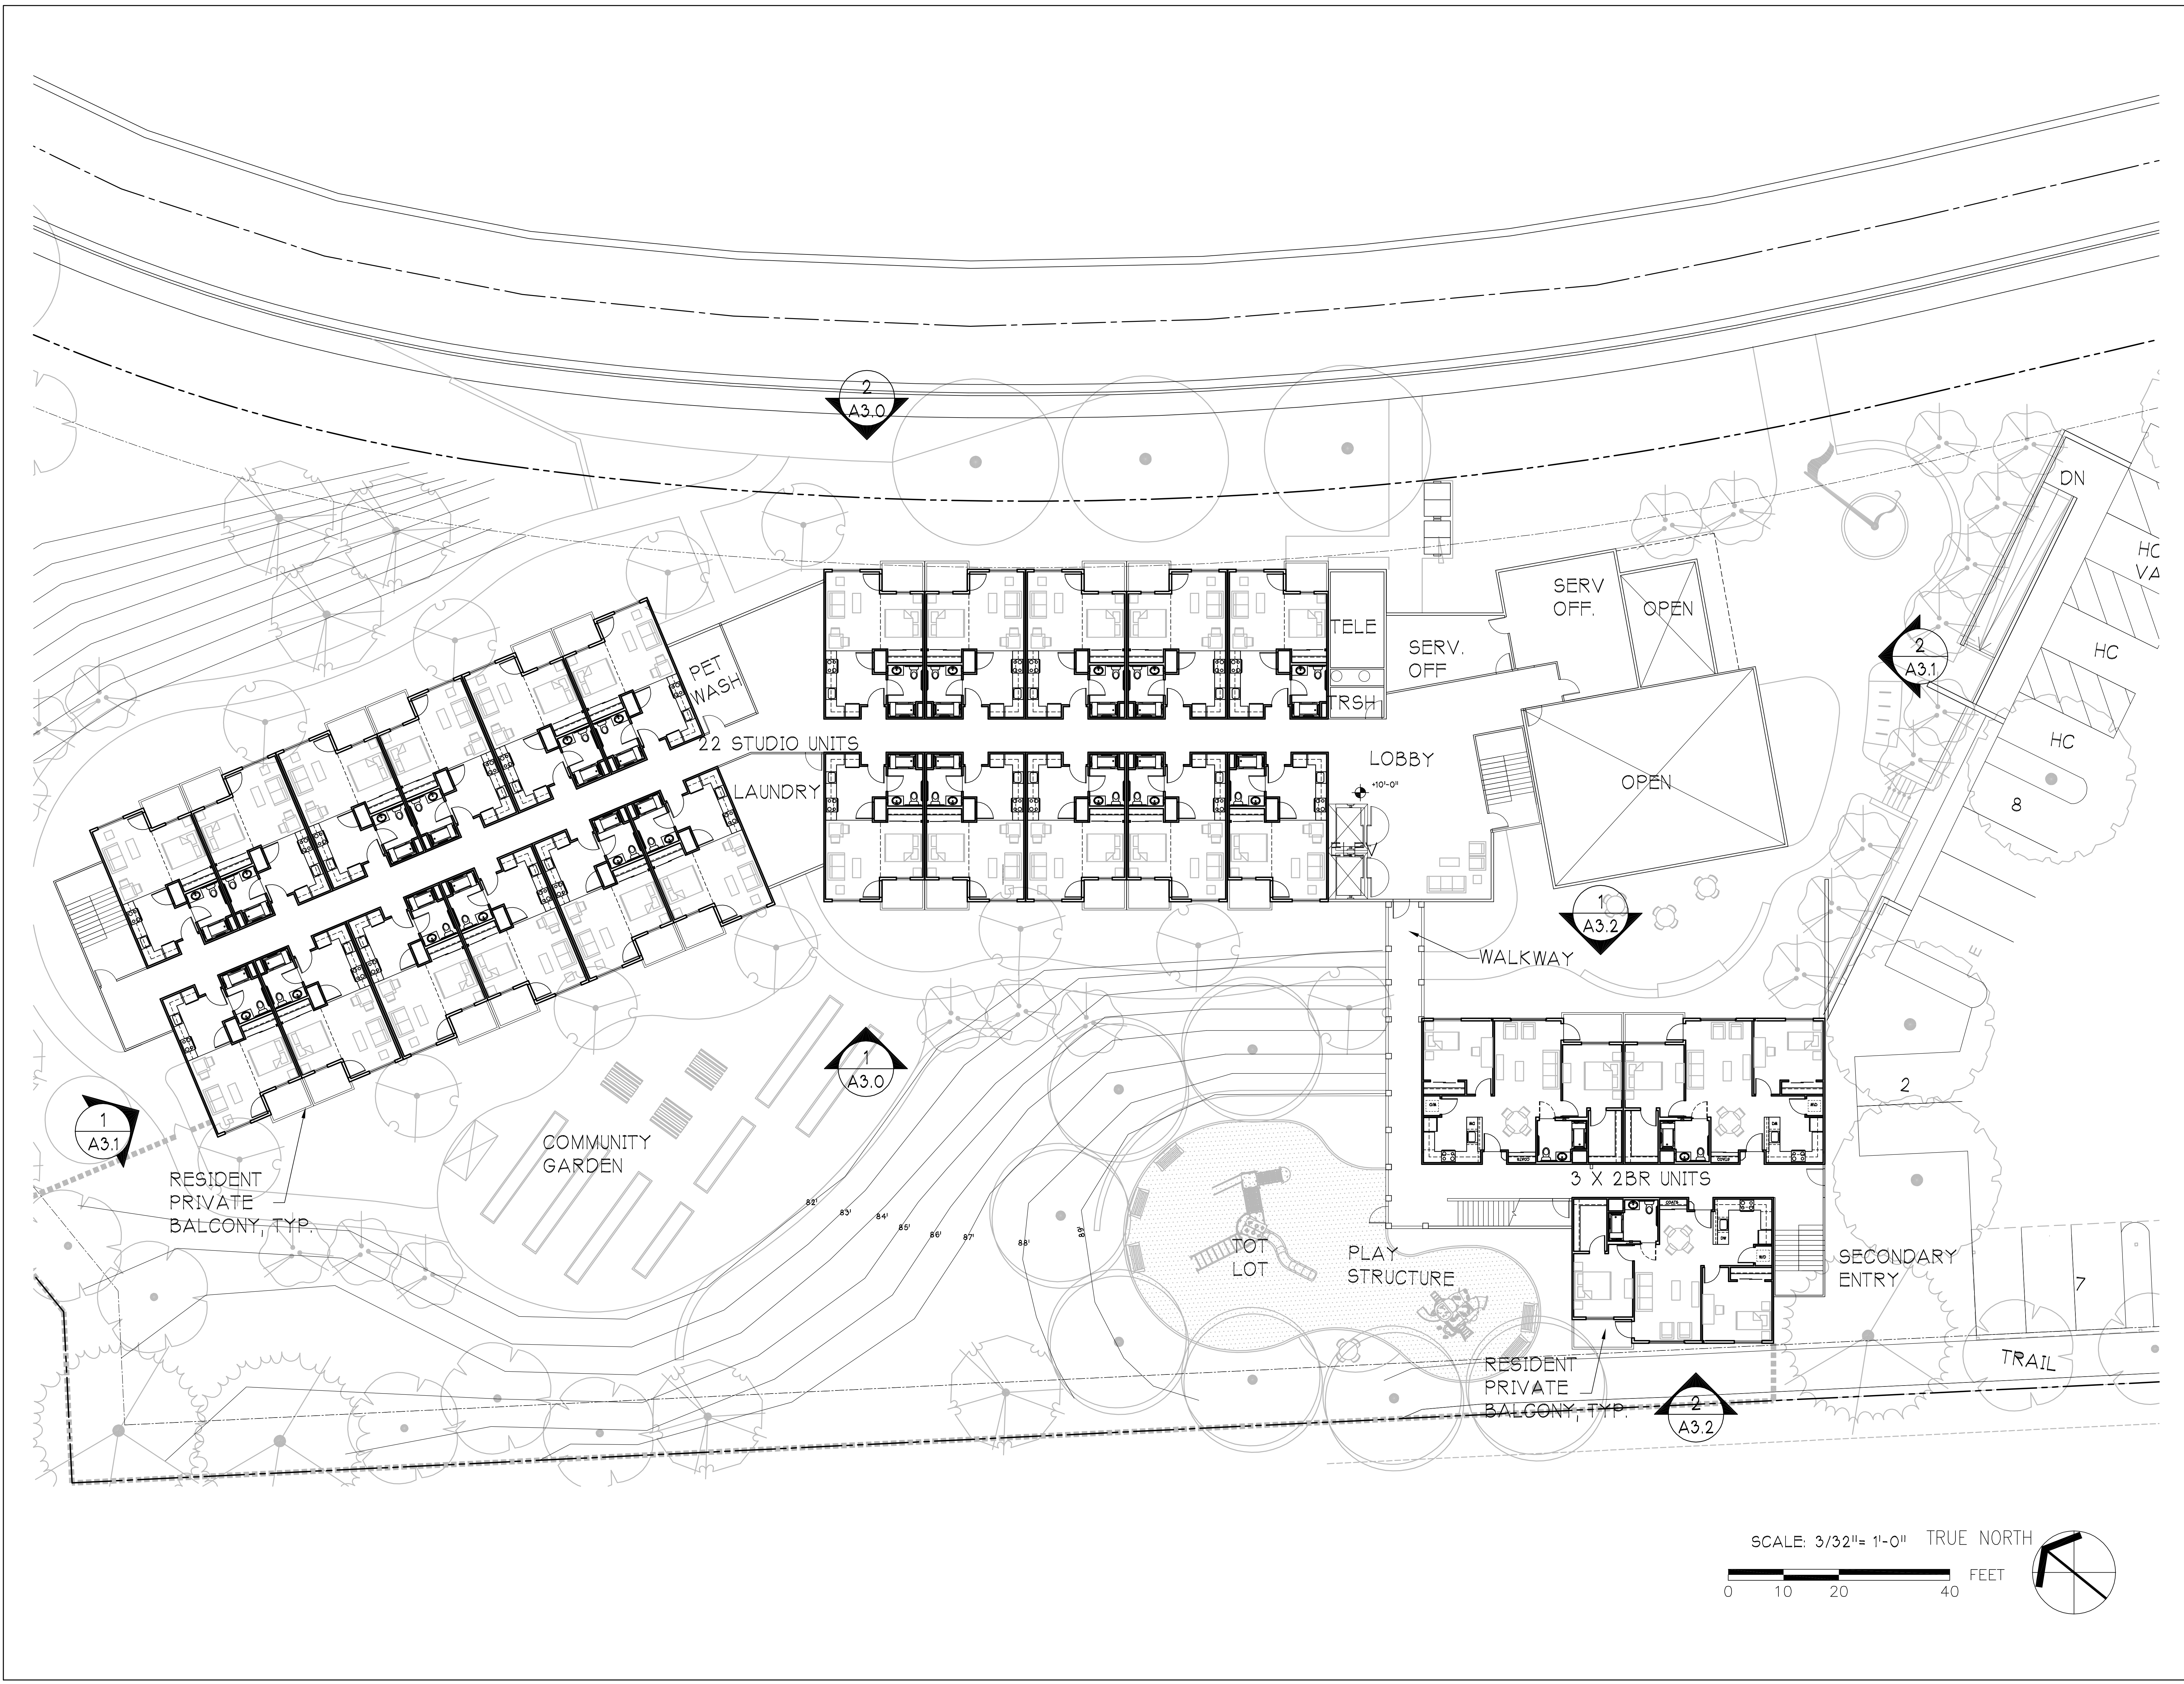
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DRAWING TITLE
SITE PLAN

SCALE AS NOTED

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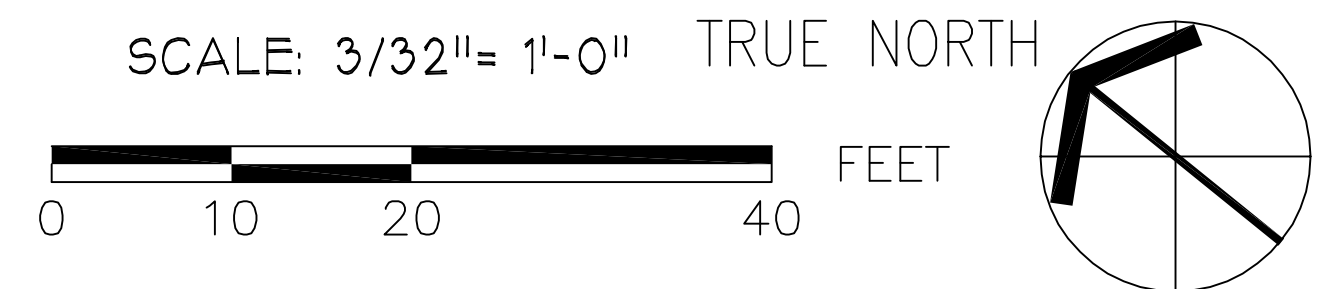


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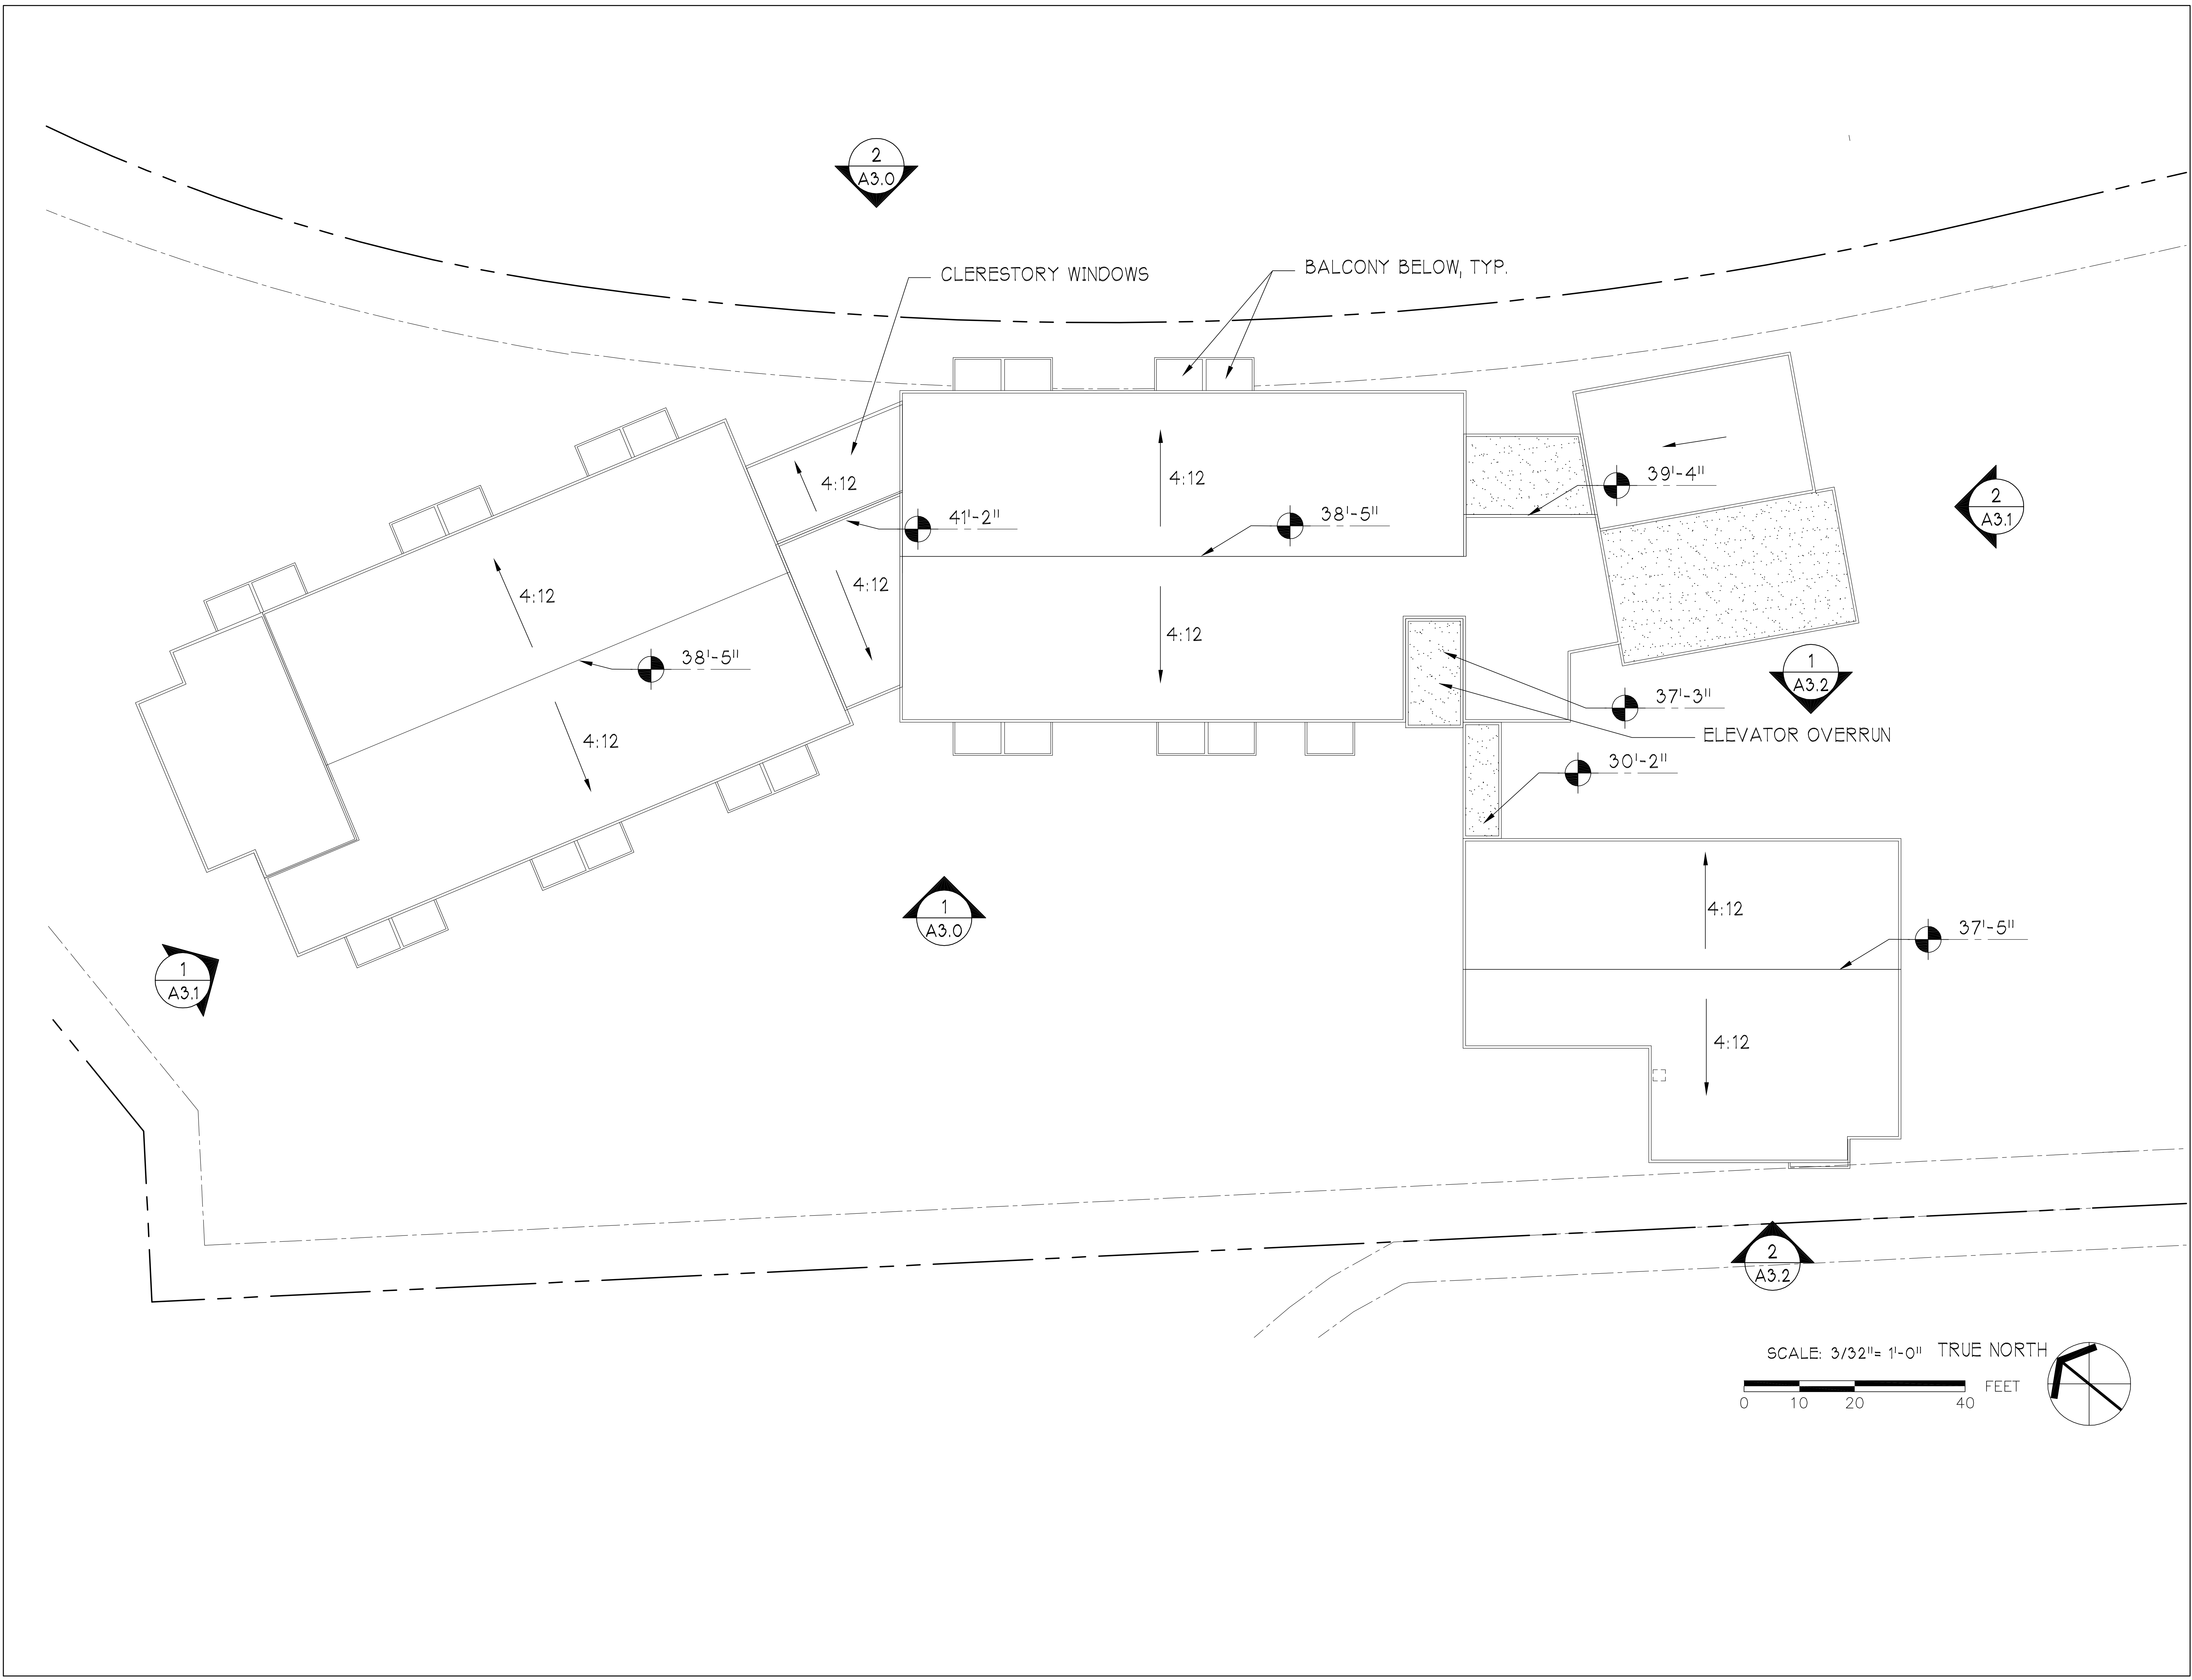
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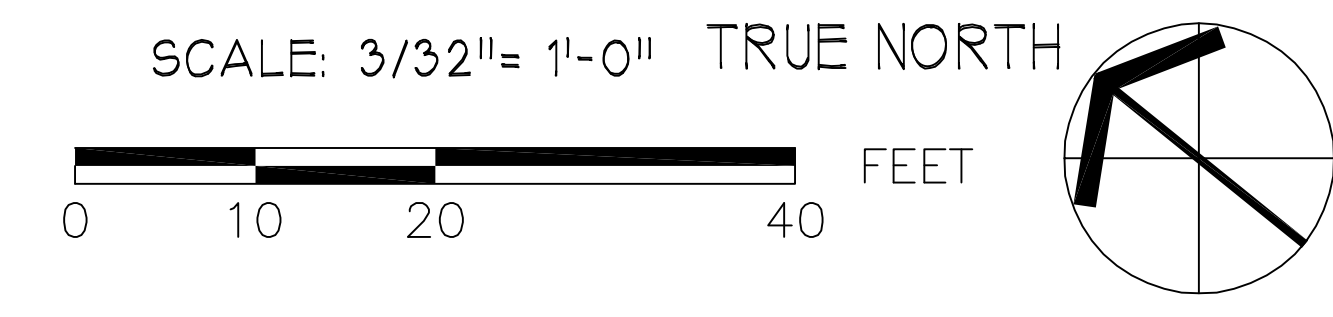
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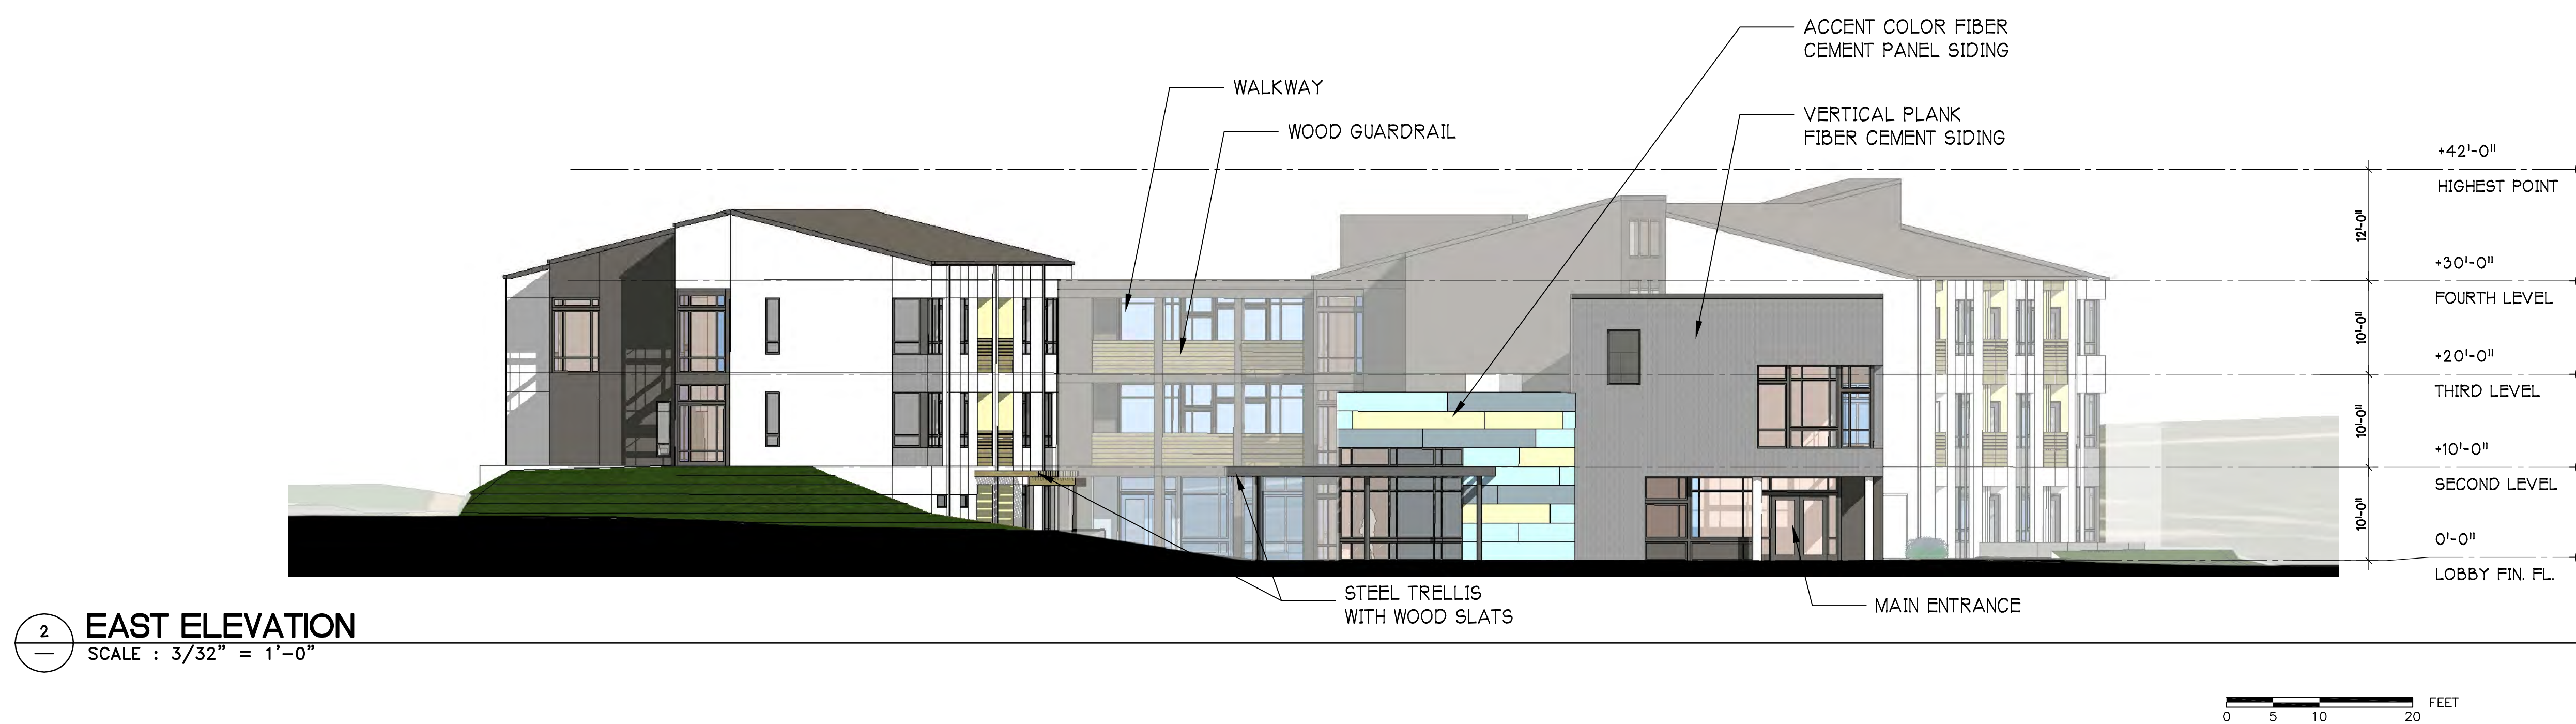
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ROOF PLAN

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